CONSTRUCTION DOCUMENTS:

ROOFING IMPROVEMENTS - SUMMER 2023

304 N. MAIN STREET LINDENWOOD, ILLINOIS 61049

BOARD OF EDUCATION - ESWOOD CCSD #269

EACH CONTRACTOR SHALL PROVIDE ALL WORK IN CONFORMANCE WITH

EACH CONTRACTOR SHALL INSTALL MATERIALS IN ACCORDANCE WITH

EACH CONTRACTOR SHALL PROVIDE ALL CUTTING AND PATCHING AS

FRAMING MEMBERS AND SHALL BE INSTALLED IN SUCH A MANNER AS TO

NOT OVERLOAD THE EXISTING STRUCTURE BEYOND ITS ORIGINAL DESIGN

BUILDING WALLS AND CONSTRUCTION AND AVOID CONFLICT WITH OTHER

PRIOR ACCEPTANCE OF THE ARCHITECT, UNLESS SPECIFICALLY CALLED OUT

CEILING CONSTRUCTION, RUN CABLE, CONDUIT, PIPE, DUCTWORK, ETC. IN A

EACH CONTRACTOR SHALL REPAIR DAMAGE TO EXISTING CONSTRUCTION TO REMAIN CAUSED BY HIS OPERATIONS AT HIS OWN EXPENSE. REPLACEMENT

CONSTRUCTION SHALL BE TO AN "AS-NEW" CONDITION. MATCH ADJACENT,

THE GENERAL CONTRACTOR SHALL COORDINATE ACCEPTABLE TIME FOR

THE USE OF UTILITIES, ELEVATORS, ACCEPTABLE ENTRANCES OF WORKERS,

ETC. WITH THE PROPERTY MANAGER PRIOR TO THE COMMENCEMENT OF THE

MORK. DAILY MORKING HOURS SHALL BE AS DICTATED BY THE PROPERTY MANAGER. ANY DISRUPTIONS TO UTILITIES (ELECTRICAL, MATER, ETC.)

MAY BE PERMITTED OUTSIDE THE BUILDING, ONLY IF AND WHERE ALLOWED

COMPLY WITH ALL CONSTRUCTION REQUIREMENTS PROVIDED BY THE PROPERTY MANAGER. WHERE PROPERTY MANAGER'S REQUIREMENTS ARE

THE GENERAL CONTRACTOR SHALL PROVIDE COORDINATION BETWEEN

TRADES TO FACILITATE JOB COMPLETION IN AN EFFICIENT AND TIMELY

EACH CONTRACTOR SHALL VERIFY THAT PRECEDING WORK IS CORRECT

BEFORE COMMENCEMENT OF DEPENDENT WORK. DISCREPANCIES SHALL BE

VENTILATION: PORTIONS OF THE BUILDING'S NORMAL VENTILATION SYSTEM

MAY OPERATE DURING CONSTRUCTION. WHERE CONSTRUCTION RESULTS IN

ABOVE-NORMAL LEVELS OF DUST BEING INTRODUCED INTO THE AIR (SUCH

TEMPORARY FILTERED RETURN AIR GRILLES TO PREVENT CONSTRUCTION

LTER(S) AS REQUIRED TO MAINTAIN AN ADEQUATE AIR FLOW AND MINIMIZE

THE AMOUNT OF CONSTRUCTION DUST ENTERING THE SYSTEM. COVER ALL

CONTAMINANTS INTO DUCTWORK TO BE REUSED. PROTECT AIR INLETS AND

DEBRIS DURING PERIOD OF CONSTRUCTION, CLEAN UNITS TO SATISFACTION

TEMPORARY SUPPLEMENTAL VENTILATION AS REQUIRED BY CONSTRUCTION

CONTRACTOR TO USE EXISTING HEATING AND VENTILATION EQUIPMENT AS

OPERATIONAL, THE CONTRACTOR SHALL PROVIDE TEMPORARY HEAT AS

VENTILATION" ABOVE. IF THE CONTRACTOR DOES NOT COMPLY WITH THE

REQUIRED BY CONSTRUCTION OPERATIONS. THE CONTRACTOR WILL NOT BE

CONSTRUCTION WATER: THE PROPERTY MANAGER AND TENANT WILL ALLOW

CONTRACTORS TO USE THE EXISTING FACILITIES. CONTRACTOR WILL NOT BE RESPONSIBLE FOR UTILITY CHARGES.

CONTRACTOR TO USE EXISTING TOILET FACILITIES AND WILL PAY WATER UTILITY FEES. ABUSIVE USE OF TOILET FACILITIES OR IF NO EXISTING TOILET

TEMPORARY TOILET FACILITIES WILL REQUIRE THE APPROVAL OF THE PROPERTY MANAGER. DO NOT CLEAN BRUSHES, TOOLS OR CONSTRUCTION

ELECTRICAL: THE PROPERTY MANAGER AND TENANT WILL ALLOW THE

SECURITY: THE GENERAL CONTRACTOR SHALL LEAVE THE JOB SITE LOCKED, SECURED AND WATER-TIGHT AT THE END OF EACH WORK DAY.

ANY CONTRACTOR REQUIRED TO CREATE NEW OPENINGS IN PERIMETER

WALLS OR ROOFING SYSTEMS OR REMOVE WINDOWS OR DOORS SHALL

SECURE THE BUILDING. TEMPORARY INFILL OR COVERINGS SHALL BE

WATER INFILTRATION WILL BE THE RESPONSIBILITY OF THE GENERAL

FROM CONSTRUCTION NOISE AND DEBRIS.

SECURE THOSE OPENINGS AT THE END OF EACH WORK DAY. PROVIDE A LOCKABLE AND WEATHER-PROOF DOOR, WINDOW OR BARRICADE TO

VANDAL-PROOF AND WATER-TIGHT. ANY DAMAGE DUE TO VANDALISM OR

8. PROVIDE TEMPORARY DUST/SOUND BARRIERS THROUGHOUT THE PERIOD OF CONSTRUCTION AS REQUIRED TO PROTECT ADJACENT OCCUPIED AREAS

CONTRACTORS TO USE THE EXISTING ELECTRICAL SERVICE. THE

CONTRACTOR WILL NOT BE RESPONSIBLE FOR ELECTRICAL UTILITY

FACILITIES ARE FUNCTIONAL, THE GENERAL CONTRACTOR SHALL PROVIDE EMPORARY TOILET FACILITIES AT HIS EXPENSE. THE LOCATION OF

CHARGES. ALL TEMPORARY POWER AND LIGHTING SHALL BE PROVIDED BY

THE CONTRACTOR AND SHALL BE REMOVED PRIOR TO OCCUPANCY BY THE

LONG AS THE CONTRACTOR COMPLIES WITH THE REQUIREMENTS IN

ISCHARGES FROM CONSTRUCTION DEBRIS THROUGHOUT PERIOD OF

OF THE OWNER AND TENANT. THE CONTRACTOR SHALL PROVIDE ALL

CONSTRUCTION. IF UNITS BECOME CONTAMINATED WITH CONSTRUCTION

AS DEMOLITION OF DRYWALL CONSTRUCTION, ETC.), CONSTRUCT DUST

DUST FROM ENTERING INTO THE VENTILATION SYSTEM. REPLACE THE

SUPPLY AND RETURN OPENINGS AT GRILLES AND IN DUCTWORK OF

PORTIONS OF THE SYSTEM NOT OPERATING TO AVOID ENTRY OF

HEAT: THE PROPERTY MANAGER AND TENANT WILL ALLOW THE

REQUIREMENTS NOTED ABOVE, OR IF NO EXISTING EQUIPMENT IS

TELEPHONE: SERVICES DESIRED BY THE CONTRACTOR SHALL BE

SANITARY: THE PROPERTY MANAGER AND TENANT WILL ALLOW THE

RESPONSIBLE FOR UTILITY CHARGES.

CONTRACTOR.

PROVIDED AND PAID FOR BY THE CONTRACTOR

BARRIERS AROUND THE AREA OF CONSTRUCTION AND PROVIDE

MORE STRINGENT THAN THOSE IN THE CONSTRUCTION DOCUMENTS, COMPLY

SHALL BE COORDINATED 48 HOURS PRIOR TO SCHEDULED DISRUPTION

POSSESSION OF ALCOHOL OR ILLEGAL DRUGS WILL NOT BE PERMITTED

MITHIN THE BUILDING OR MITHIN BOUNDARIES OF THE LANDLORD'S
PROPERTY SMOKING IS NOT PERMITTED INSIDE THE BUILDING SM

REQUIREMENTS ARE UNCLEAR, CONTACT THE ARCHITECT FOR CLARIFICATION

MANNER THAT OFFERS THE BEST POSSIBLE APPEARANCE. WHERE THESE

CAPACITY. DO NOT HANG NEW CONSTRUCTION FROM EXISTING METAL

AS SUCH ON THE CONSTRUCTION DOCUMENTS. IN AREAS OF EXPOSED

DECK, DUCTWORK, SERVICE PIPE, ETC. RUN PIPING PARALLEL WITH

ALL NEW CONSTRUCTION SHALL BE SUPPORTED FROM STRUCTURAL

APPLICABLE MANUFACTURER'S WRITTEN INSTRUCTIONS AND

BY THE FEDERAL DEPARTMENT OF JUSTICE.

AND STANDARDS APPLICABLE TO THE WORK.

REQUIRED TO COMPLETE HIS WORK.

BUILDING SERVICES.

UNDAMAGED FINISHES.

PROPERTY MANAGER CRITERIA

BY THE PROPERTY MANAGER

TEMPORARY FACILITIES


WITH PROPERTY MANAGER'S REQUIREMENTS.

REPORTED TO THE ARCHITECT IMMEDIATELY.

FEDERAL, STATE, AND LOCAL CODES AND REQUIREMENTS HAVING LAWFUL

JURISDICTION INCLUDING THE CURRENT EDITION OF THE ACCESSIBILITY CODE AND "ADA ACCESSIBILITY GUIDELINES FOR BUILDINGS AND FACILITIES

RECOMMENDATIONS AND COMPLY WITH GOVERNING INDUSTRY REGULATIONS

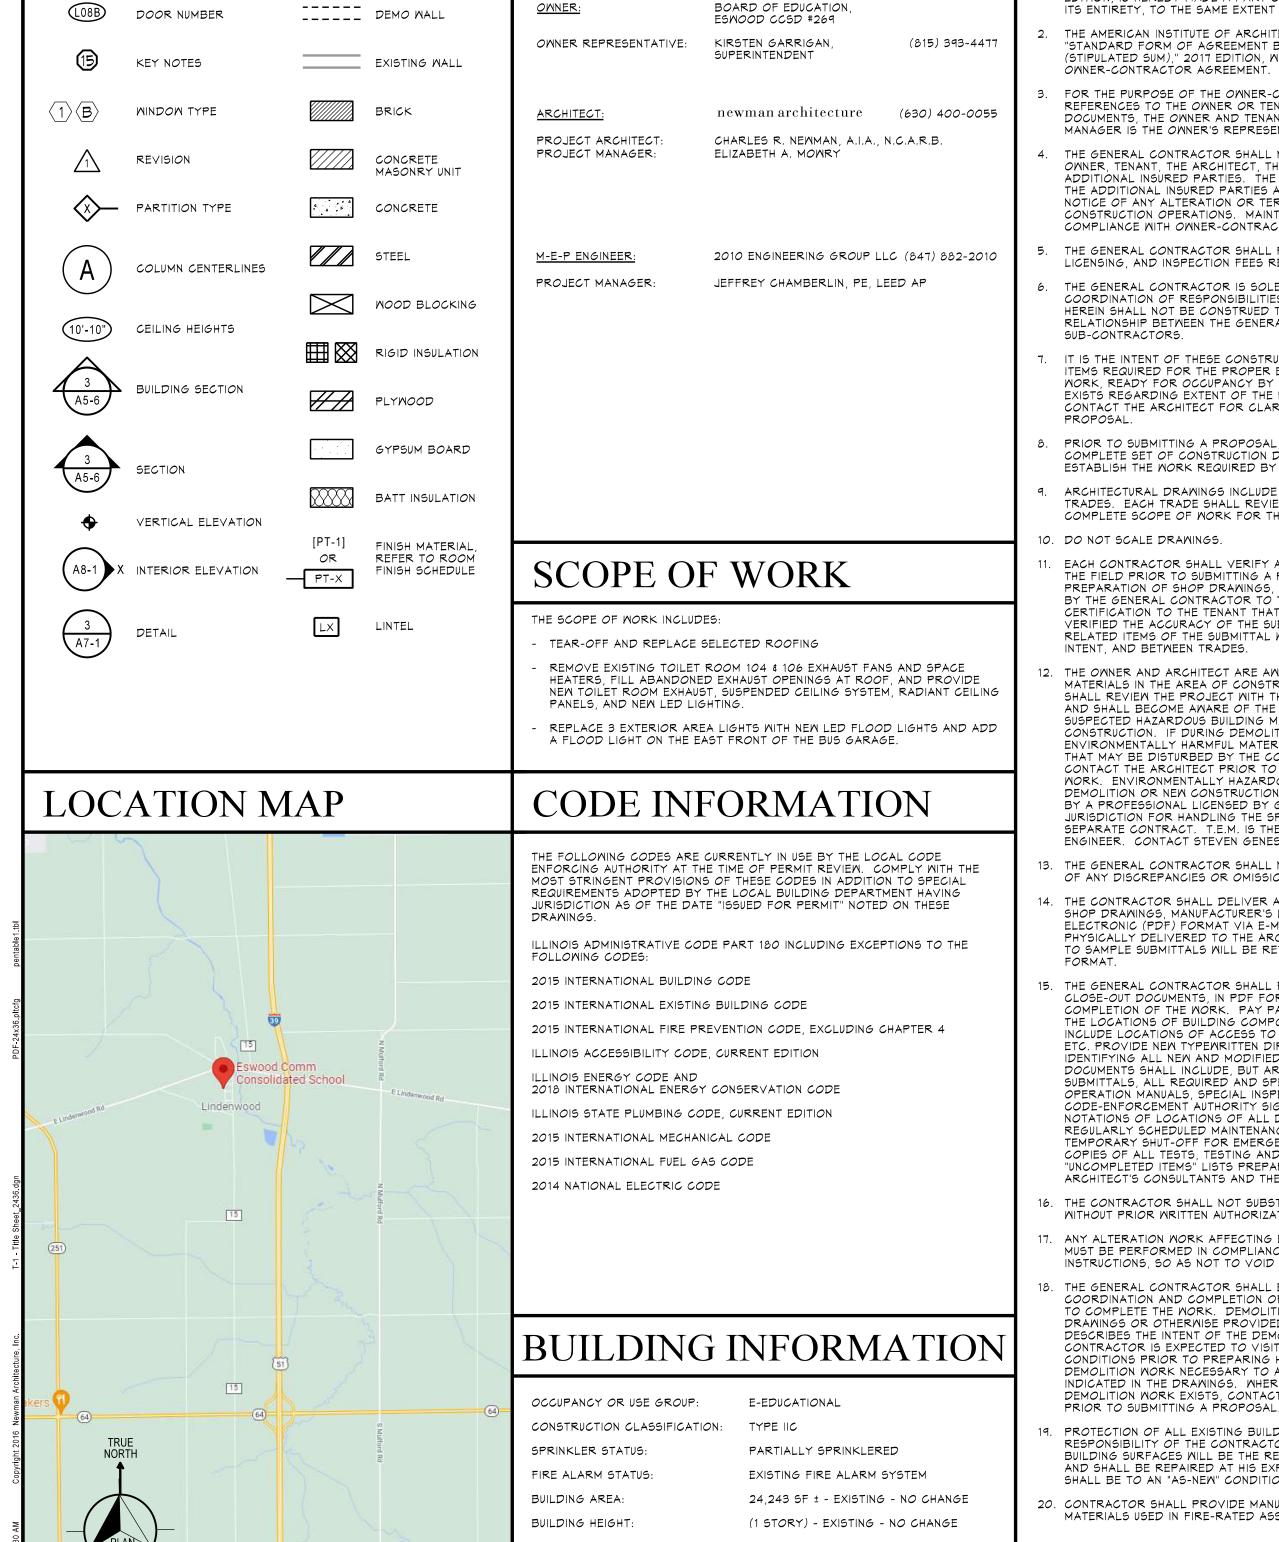

SYMBOLS/MATERIALS

Google

310

ROOM NUMBER

GENERAL INFORMATION

PARTICIPATING ORGANIZATIONS:

THE AMERICAN INSTITUTE OF ARCHITECTS DOCUMENT A201, ENTITLED "GENERAL CONDITIONS OF THE CONTRACT FOR CONSTRUCTION", 2017 EDITION, IS HEREBY MADE A PART OF THESE CONSTRUCTION DOCUMENTS IN ITS ENTIRETY, TO THE SAME EXTENT AS IF REPEATED VERBATIM HEREIN.

GENERAL NOTES

GENERAL NOTES

- THE AMERICAN INSTITUTE OF ARCHITECTS DOCUMENT A101, ENTITLED "STANDARD FORM OF AGREEMENT BETWEEN OWNER AND CONTRACTOR (STIPULATED SUM)," 2017 EDITION, WILL FORM THE BASIS FOR THE OWNER-CONTRACTOR AGREEMENT.
- FOR THE PURPOSE OF THE OWNER-CONTRACTOR AGREEMENT AND REFERENCES TO THE OWNER OR TENANT THROUGHOUT THE CONSTRUCTION DOCUMENTS, THE OWNER AND TENANT ARE THE SAME. THE PROPERTY MANAGER IS THE OWNER'S REPRESENTATIVE
- THE GENERAL CONTRACTOR SHALL MAINTAIN INSURANCE WHICH LISTS THE OWNER, TENANT, THE ARCHITECT, THEIR EMPLOYEES AND THEIR AGENTS, AS ADDITIONAL INSURED PARTIES. THE CONTRACTOR SHALL GIVE EACH OF THE ADDITIONAL INSURED PARTIES A MINIMUM OF 10 DAYS PRIOR WRITTEN NOTICE OF ANY ALTERATION OR TERMINATION OF COVERAGE DURING CONSTRUCTION OPERATIONS. MAINTAIN MINIMUM COVERAGE IN COMPLIANCE WITH OWNER-CONTRACTOR CONTRACT REQUIREMENTS.
- THE GENERAL CONTRACTOR SHALL PROCURE AND PAY FOR ALL PERMITS, LICENSING, AND INSPECTION FEES REQUIRED BY THE WORK.
- THE GENERAL CONTRACTOR IS SOLELY RESPONSIBLE FOR THE COORDINATION OF RESPONSIBILITIES OF EACH TRADE. NOTES CONTAINED HEREIN SHALL NOT BE CONSTRUED TO DEFINE THE CONTRACTUAL RELATIONSHIP BETWEEN THE GENERAL CONTRACTOR AND HIS
- IT IS THE INTENT OF THESE CONSTRUCTION DOCUMENTS TO INCLUDE ALL ITEMS REQUIRED FOR THE PROPER EXECUTION AND COMPLETION OF THE WORK, READY FOR OCCUPANCY BY THE TENANT. WHERE A QUESTION EXISTS REGARDING EXTENT OF THE RESPONSIBILITY OF THE CONTRACTOR CONTACT THE ARCHITECT FOR CLARIFICATION PRIOR TO SUBMITTING A
- PRIOR TO SUBMITTING A PROPOSAL, CONTRACTORS SHALL REVIEW THE COMPLETE SET OF CONSTRUCTION DOCUMENTS AND VISIT THE SITE TO ESTABLISH THE WORK REQUIRED BY EACH TRADE.
- ARCHITECTURAL DRAMINGS INCLUDE IMPORTANT INFORMATION FOR ALL TRADES. EACH TRADE SHALL REVIEW ALL DRAWINGS TO DETERMINE THE COMPLETE SCOPE OF WORK FOR THEIR TRADE.
- EACH CONTRACTOR SHALL VERIFY ALL CONDITIONS AND DIMENSIONS IN THE FIELD PRIOR TO SUBMITTING A PROPOSAL AND AGAIN DURING THE PREPARATION OF SHOP DRAWINGS, ETC. SUBMISSION OF SHOP DRAWINGS BY THE GENERAL CONTRACTOR TO THE ARCHITECT IS THE CONTRACTOR'S CERTIFICATION TO THE TENANT THAT THE GENERAL CONTRACTOR HAS VERIFIED THE ACCURACY OF THE SUBMITTAL AND HAS COORDINATED ALL RELATED ITEMS OF THE SUBMITTAL WITH THE FIELD CONDITIONS, DESIGN INTENT, AND BETWEEN TRADES.
- 12. THE OWNER AND ARCHITECT ARE AWARE OF HAZARDOUS BUILDING MATERIALS IN THE AREA OF CONSTRUCTION. THE GENERAL CONTRACTOR SHALL REVIEW THE PROJECT WITH THE BUILDING OWNER'S REPRESENTATIVE AND SHALL BECOME AWARE OF THE LOCATION AND EXTENT OF ANY SUSPECTED HAZARDOUS BUILDING MATERIALS IN THE AREA OF CONSTRUCTION. IF DURING DEMOLITION OR CONSTRUCTION OPERATIONS ENVIRONMENTALLY HARMFUL MATERIALS ARE DISCOVERED OR SUSPECTED THAT MAY BE DISTURBED BY THE CONTRACTOR'S WORK, IMMEDIATELY CONTACT THE ARCHITECT PRIOR TO COMMENCEMENT OF THE RELATED WORK. ENVIRONMENTALLY HAZARDOUS MATERIALS AFFECTED BY DEMOLITION OR NEW CONSTRUCTION MUST BE REMOVED OR ENCAPSULATED BY A PROFESSIONAL LICENSED BY GOVERNMENTAL AUTHORITIES HAVING JURISDICTION FOR HANDLING THE SPECIFIC MATERIALS INVOLVED UNDER A SEPARATE CONTRACT. T.E.M. IS THE OWNER'S ENVIRONMENTAL DESIGN ENGINEER. CONTACT STEVEN GENESER @ 630-790-0880.
- 13. THE GENERAL CONTRACTOR SHALL NOTIFY THE ARCHITECT IMMEDIATELY OF ANY DISCREPANCIES OR OMISSIONS ENCOUNTERED FOR CLARIFICATION.
- 14. THE CONTRACTOR SHALL DELIVER ALL WRITTEN SUBMITTALS, INCLUDING SHOP DRAWINGS, MANUFACTURER'S LITERATURE, ETC. TO THE ARCHITECT IN ELECTRONIC (PDF) FORMAT VIA E-MAIL. ALL SAMPLES SHALL BE PHYSICALLY DELIVERED TO THE ARCHITECT FOR EVALUATION. RESPONSES TO SAMPLE SUBMITTALS WILL BE RETURNED BY THE ARCHITECT IN PDF
- 15. THE GENERAL CONTRACTOR SHALL FURNISH A COMPLETE SET OF CLOSE-OUT DOCUMENTS, IN PDF FORMAT, TO THE ARCHITECT UPON COMPLETION OF THE WORK. PAY PARTICULAR ATTENTION TO IDENTIFYING THE LOCATIONS OF BUILDING COMPONENTS REQUIRING FUTURE SERVICE. NCLUDE LOCATIONS OF ACCESS TO DUCTWORK, PIPING, AND RACEWAYS ETC. PROVIDE NEW TYPEWRITTEN DIRECTORIES IN ELECTRICAL PANELS DENTIFYING ALL NEW AND MODIFIED ELECTRICAL CIRCUITS. CLOSE-OUT DOCUMENTS SHALL INCLUDE, BUT ARE NOT LIMITED TO: ACCEPTED SUBMITTALS, ALL REQUIRED AND SPECIAL WARRANTIES, MAINTENANCE AND OPERATION MANUALS, SPECIAL INSPECTION REPORTS, FINAL CODE-ENFORCEMENT AUTHORITY SIGN OFFS, RECORD DRAWINGS INCLUDING NOTATIONS OF LOCATIONS OF ALL DEVICES/EQUIPMENT REQUIRING REGULARLY SCHEDULED MAINTENANCE OR DEVICE LOCATIONS NEEDED FOR TEMPORARY SHUT-OFF FOR EMERGENCY OR MAINTENANCE SERVICE, COPIES OF ALL TESTS, TESTING AND BALANCING REPORTS, COMPLETED "UNCOMPLETED ITEMS" LISTS PREPARED BY THE ARCHITECT, THE ARCHITECT'S CONSULTANTS AND THE OWNER WITH SIGN-OFFS, ETC.
- THE CONTRACTOR SHALL NOT SUBSTITUTE MATERIALS OR EQUIPMENT MITHOUT PRIOR WRITTEN AUTHORIZATION FROM THE ARCHITECT
- ANY ALTERATION WORK AFFECTING EXISTING SYSTEMS UNDER WARRANTY MUST BE PERFORMED IN COMPLIANCE WITH THE MANUFACTURER'S WRITTEN
- INSTRUCTIONS, SO AS NOT TO VOID EXISTING WARRANTIES. THE GENERAL CONTRACTOR SHALL BE RESPONSIBLE FOR THE COORDINATION AND COMPLETION OF ALL DEMOLITION WORK NECESSARY TO COMPLETE THE WORK. DEMOLITION INFORMATION INDICATED ON THE DRAWINGS OR OTHERWISE PROVIDED ON DRAWINGS GENERALLY DESCRIBES THE INTENT OF THE DEMOLITION WORK REQUIRED. THE ONTRACTOR IS EXPECTED TO VISIT THE SITE AND EVALUATE EXISTING ONDITIONS PRIOR TO PREPARING HIS PROPOSAL. INCLUDE ALL DEMOLITION WORK NECESSARY TO ALLOW FOR CONSTRUCTION AS INDICATED IN THE DRAWINGS. WHERE A QUESTION REGARDING EXTENT OF DEMOLITION WORK EXISTS, CONTACT THE ARCHITECT FOR CLARIFICATION
- PROTECTION OF ALL EXISTING BUILDING SURFACES TO REMAIN IS THE RESPONSIBILITY OF THE CONTRACTOR. ANY DAMAGE TO EXISTING BUILDING SURFACES WILL BE THE RESPONSIBILITY OF THE CONTRACTOR AND SHALL BE REPAIRED AT HIS EXPENSE. REPLACEMENT CONSTRUCTION SHALL BE TO AN "AS-NEM" CONDITION.
- 20. CONTRACTOR SHALL PROVIDE MANUFACTURER'S DOCUMENTATION FOR ALL MATERIALS USED IN FIRE-RATED ASSEMBLIES

- THE GENERAL CONTRACTOR IS SOLELY RESPONSIBLE FOR ALL PROJECT SAFETY, INCLUDING, BUT NOT LIMITED TO, SAFETY PROGRAMS AND THE SAFETY AND PROTECTION FROM ALL EQUIPMENT, OPERATIONS, STORAGE FACILITIES AND DUMPSTERS, AND SHALL HOLD THE OWNER, TENANT, ARCHITECT AND THEIR EMPLOYEES HARMLESS FROM ALL LIABILITIES RESULTING THEREFROM.
- PRESERVE THE FIRE SAFETY INTEGRITY OF EXISTING FACILITIES DURING CONSTRUCTION OPERATIONS.
- A. ENSURE FIRE EXITS PROVIDE FREE, UNOBSTRUCTED EGRESS
- B. ENSURE FIRE ALARM, DETECTION, LIFE SAFETY NOTIFICATION AND SUPPRESSION SYSTEMS ARE FULLY OPERATIONAL OR APPROPRIATE TEMPORARY PROTECTION MEASURES ACCEPTABLE TO THE LOCAL CODE/FIRE PROTECTION AUTHORITY ARE IMPLEMENTED THROUGHOUT PERIOD OF CONSTRUCTION.
- PROVIDE TEMPORARY BARRICADES AS REQUIRED TO WARN OF UNSAFE AREAS OF CONSTRUCTION, AS JUDGED BY THE GENERAL CONTRACTOR.

NO CONDUIT, PIPING, DUCTWORK, ETC. SHALL BE RUN EXPOSED WITHOUT THE FIRESTOPPING REQUIREMENTS

- PENETRATIONS THROUGH RATED FLOOR, WALL OR ROOF ASSEMBLIES SHALL BE FIRESTOPPED WITH THRU-PENETRATION FIRESTOPPING ASSEMBLIES THAT MATCH THE FIRE RATING OF THE WALLS OR FLOORS BEING PENETRATED, AND ARE CAPABLE OF PREVENTING THE PASSAGE OF FLAMES AND HOT GASES WHEN SUBJECTED TO THE TEST METHODS SPECIFIED FOR FIRE STOPS, IN COMPLIANCE WITH ASTM E-814.
- EXISTING SPRAY-ON FIREPROOFING, INTUMESCENT PAINT, OR FIRE PROTECTION CONSTRUCTION PROTECTING STRUCTURAL MEMBERS DECK OR FIRE-RATED ASSEMBLIES THAT IS REMOVED OR DISTURBED BY CONSTRUCTION OPERATIONS SHALL BE REPAIRED OR REPLACED BY CONTRACTOR TO MATCH OR EXCEED EXISTING PROTECTION IN COMPLIANCE

- ACCEPTED: THE TERMS "ACCEPTED", "APPROVED", "REQUIRED", AND "AS DIRECTED" REFER TO AND INDICATE WORK OR MATERIALS THAT MAY BE ACCEPTED, APPROVED, OR REQUIRED BY THE OWNER.
- CODE: THE TERMS "CODE" AND "BUILDING CODE" REFER TO REGULATIONS BY GOVERNMENTAL AGENCIES HAVING LAWFUL JURISDICTION.
- CONTRACTORS OR THE CONTRACTOR: REFERS TO THE GENERAL CONTRACTOR AND ALL SUBCONTRACTORS, SUPPLIERS AND ALL OTHERS EMPLOYED DIRECTLY OR INDIRECTLY BY THE GENERAL CONTRACTOR TO COMPLETE THE WORK REQUIRED BY THIS CONTRACT.
- PROVIDE: FURNISH AND INSTALL COMPLETE IN PLACE, TESTED AND APPROVED, READY FOR USE.
- SHOWN: THE TERMS "SHOWN", "INDICATED", "DETAILED", "NOTED" SCHEDULED", AND TERMS OF SIMILAR CHARACTER REFER TO REQUIREMENTS CONTAINED IN THE CONTRACT DOCUMENTS.
- SIMILAR: THE TERM IS USED IN ITS GENERAL SENSE, AND DOES NOT NECESSARILY MEAN IDENTICAL. THE DETERMINATION OF SIMILARITY OF PRODUCTS OR APPLICATIONS IS SUBJECT TO THE APPROVAL OF THE

CLEANING

- DUMPSTERS: CONTRACTOR SHALL VERIFY ACCEPTABLE LOCATIONS OF DUMPSTER(S) WITH THE PROPERTY MANAGER. PROTECT TURF, LANDSCAPING, PAVEMENT, ETC. FROM DAMAGE AS REQUIRED. REPAIR ANY DAMAGE CAUSED BY STORAGE OR TRANSPORT OF DUMPSTERS TO THE AREA'S PRIOR CONDITION.
- CLEANING: THE GENERAL CONTRACTOR SHALL CLEAN THE WORK SPACE AT THE END OF EACH WORK DAY TO A "BROOM CLEAN" CONDITION. REMOVE DEMOLISHED MATERIALS AND REFUSE TO THE CONTRACTOR'S COVERED DUMPSTER OR LEGALLY REMOVE FROM THE SITE.

FINAL CLEAN: UPON COMPLETION OF MODIFICATIONS NOTED HEREIN, THE

CONTRACTOR SHALL PROVIDE A FINAL CLEAN OF ALL SURFACES IMPACTED BY THE WORK. THE CONTRACTOR SHALL EMPLOY A COMMERCIAL GRADE CLEANING COMPANY, EXPERIENCED WITH FACILITIES OF THIS TYPE AND SIZE, FOR FINAL CLEANING OPERATIONS. THE FINAL CLEAN SHALL INCLUDE ALL CLEANING, WAXING, BUFFING, SEALING, ETC. PER SURFACE MANUFACTURER'S RECOMMENDATIONS FOR HIGH-TRAFFIC AREAS, AS REQUIRED, READY FOR THE BUSINESS OF THE TENANT.

MAINTENANCE MATERIALS

- THE GENERAL CONTRACTOR SHALL DELIVER TO THE OWNER THE FOLLOWING MAINTENANCE MATERIALS, FROM THE SAME MANUFACTURED LOT USED IN CONSTRUCTION, ENCLOSED IN PROTECTIVE PACKAGING WITH APPROPRIATE IDENTIFYING LABELS:
- ACOUSTIC CEILING TILE: FURNISH QUANTITY OF FULL SIZE UNITS EQUAL TO 5% OF AMOUNT INSTALLED
- B. ACOUSTIC CEILING SUSPENSION SYSTEM: NOT LESS THAN 2% OF EACH COMPONENT TYPE INSTALLED.
- PAINT: FURNISH REMAINDER OF GALLON OF EACH COLOR / FINISH APPLIED BUT IN NO CASE LESS THAN 1/2 GALLON. SEAL IN AN AIRTIGHT CONTAINER.
- D. REFER TO MEP DRAWINGS FOR MEP MAINTENANCE MATERIALS.

COORDINATE ANY AVAILABLE ON-SITE TEMPORARY STORAGE FACILITIES AVAILABLE WITH THE PROPERTY MANAGER. THE CONTRACTOR SHALL PROVIDE ALL ADDITIONAL TEMPORARY STORAGE FACILITIES REQUIRED TO PERFORM THE WORK AT HIS EXPENSE.

THE CONTRACTOR SHALL TEMPORARILY MOVE ALL FURNISHINGS AND

EQUIPMENT AS REQUIRED TO COMPLETE THE WORK.

DRAWING INDEX

GENERAL INFORMATION

- T GENERAL PROJECT INFORMATION T-1 TITLE SHEET / GENERAL PROJECT INFORMATION
- ARCHITECTURAL A2 FLOOR PLANS
- A2-0 SITE PLAN
- A2-1 PARTIAL FIRST FLOOR PLAN A2-R PARTIAL ROOF PLAN
- A3 ENLARGED PLANS AND DETAILS A3-1 ENLARGED PLANS & REFLECTED CEILING PLANS & DETAILS

MECHANICAL

- ENLARGED HVAC PLANS HV2-1ENLARGED HVAC PLANS HV2-R HVAC ROOF PLAN
- HVAC LEGENDS & DETAILS HV3-1HVAC SCHEDULES, SYMBOLS, AND DETAILS

ELECTRICAL

- ED ELECTRICAL DEMOLITION PLANS ED2-1PARTIAL FIRST FLOOR ELECTRICAL EMOLITION PLAN
- E2 ELECTRICAL PLANS
- E2-1 PARTIAL FIRST FLOOR ELECTRICAL PLAN E2-2 ELECTRICAL SITE PLAN
- E3 ELECTRICAL SCHEDULES, RISER DIAGRAMS AND
 - E3-1 ELECTRICAL SYMBOLS AND DETAILS

DRAWING NAMING KEY

DRAWING TYPE

FLOOR LEVEL OR NUMERIC ORDER

PROFESSIONAL DISCIPLINE

OF DRAWING WITHIN DRAWING TYPE

newman architecture 1730 Park Street, Suite 115, Naperville, Illinois 60563-2611 (630) 420-1600 FAX (630) 420-1987 www.newmanarchitecture.com

Participating Consultants:

20/10 Engineering Group, LLC 1216 Tower Rd, Schaumburg, IL 60173 (847) 882-2010

Project Name:

SCHOOL

CONSTRUCTION DOCUMENTS **ESWOOD**

ROOFING IMPROVEMENTS -

ESWOOD ELEMENTARY SCHOOL 304 N. MAIN STREET LINDENWOOD, ILLINOIS 61049

SUMMER 2023

BOARD OF EDUCATION ESWOOD CCSD 269

Architect's Certification



License: Illinois Professional Design Firm License No. <u>184-000549</u>

Expires: <u>2025-05-30</u> License: Illinois Registration No. 001-009496

Expires: <u>2024-11-30</u>

I hereby certify that these plans were prepared by or under my direct supervision and to the best of my professional knowledge they conform to the Accessibility Code and local building

T-1, A1-1, A2-1, A2-R, A3-1, A3-2, A8-1

codes having jurisdiction. The following drawings have been prepared under my direct supervision

Drawing Title:

TITLE SHEET **GENERAL PROJECT INFORMATION**

<u> Issue:/ Revision</u>

No. Date Description 2023-04-18 For Bidding

Project Manager: CRN Project No.: 2022052 Date: 2023-04-18

KEY PLAN

DRAWING A2-0 KEYED NOTES


REPLACE FIXTURE

REPLACE EXISTING AREA LIGHT FIXTURE WITH NEW LED FLOOD LIGHT FIXTURE. SEE MEP DRAWINGS.

NEW FLOOD LIGHT FIXTURE

PROVIDE NEW LED FLOOD LIGHT FIXTURE. SEE MEP DRAWINGS.

	SY	MBOL LEGEND							
	SYMBOL	DESCRIPTION							
		PROPERTY LINE							
	· — — — —	OVERHEAD ELECTRICAL WIRES							
	#	UTILITY POLE							
	Я	FIRE HYDRANT							
	N	MATER SUPPLY							
	G	GAS SUPPLY							
	EE	ELECTRICAL SUPPLY							
	5T	STORM LINE							
	SN	SANITARY LINE							
-	Ý	AREA LIGHT TO BE REPLACED							
	þ	FLOOD LIGHT TO REPLACE AREA LIGHT							

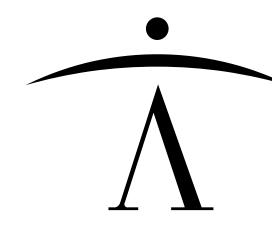

newman architecture
1730 Park Street, Suite 115, Naperville, Illinois 60563-2611
(630) 420-1600 FAX (630) 420-1987 www.newmanarchitecture.com

Participating Consultants:

20/10 Engineering Group, LLC 1216 Tower Rd, Schaumburg, IL 60173 (847) 882-2010

Project Name:

CONSTRUCTION DOCUMENTS
ESWOOD
SCHOOL

ROOFING IMPROVEMENTS -SUMMER 2023

ESWOOD ELEMENTARY SCHOOL 304 N. MAIN STREET LINDENWOOD, ILLINOIS 61049

BOARD OF EDUCATION ESWOOD CCSD 269

Architect's Certification:



License: Illinois Professional Design Firm License No. 184-000549

Expires: 2025-05-30

License: Illinois Registration No. 001-009496

Expires: 2024-11-30

Charles R Newman


Drawing Title:
SITE LIFE SAFETY SITE
REFERENCE PLAN

Issue:/ Revision:


No. Date Description
- 2023-04-18 For Bidding


Project Manager: CRN
Project No.: 2022052 Date: 2023-04-18

A2-0

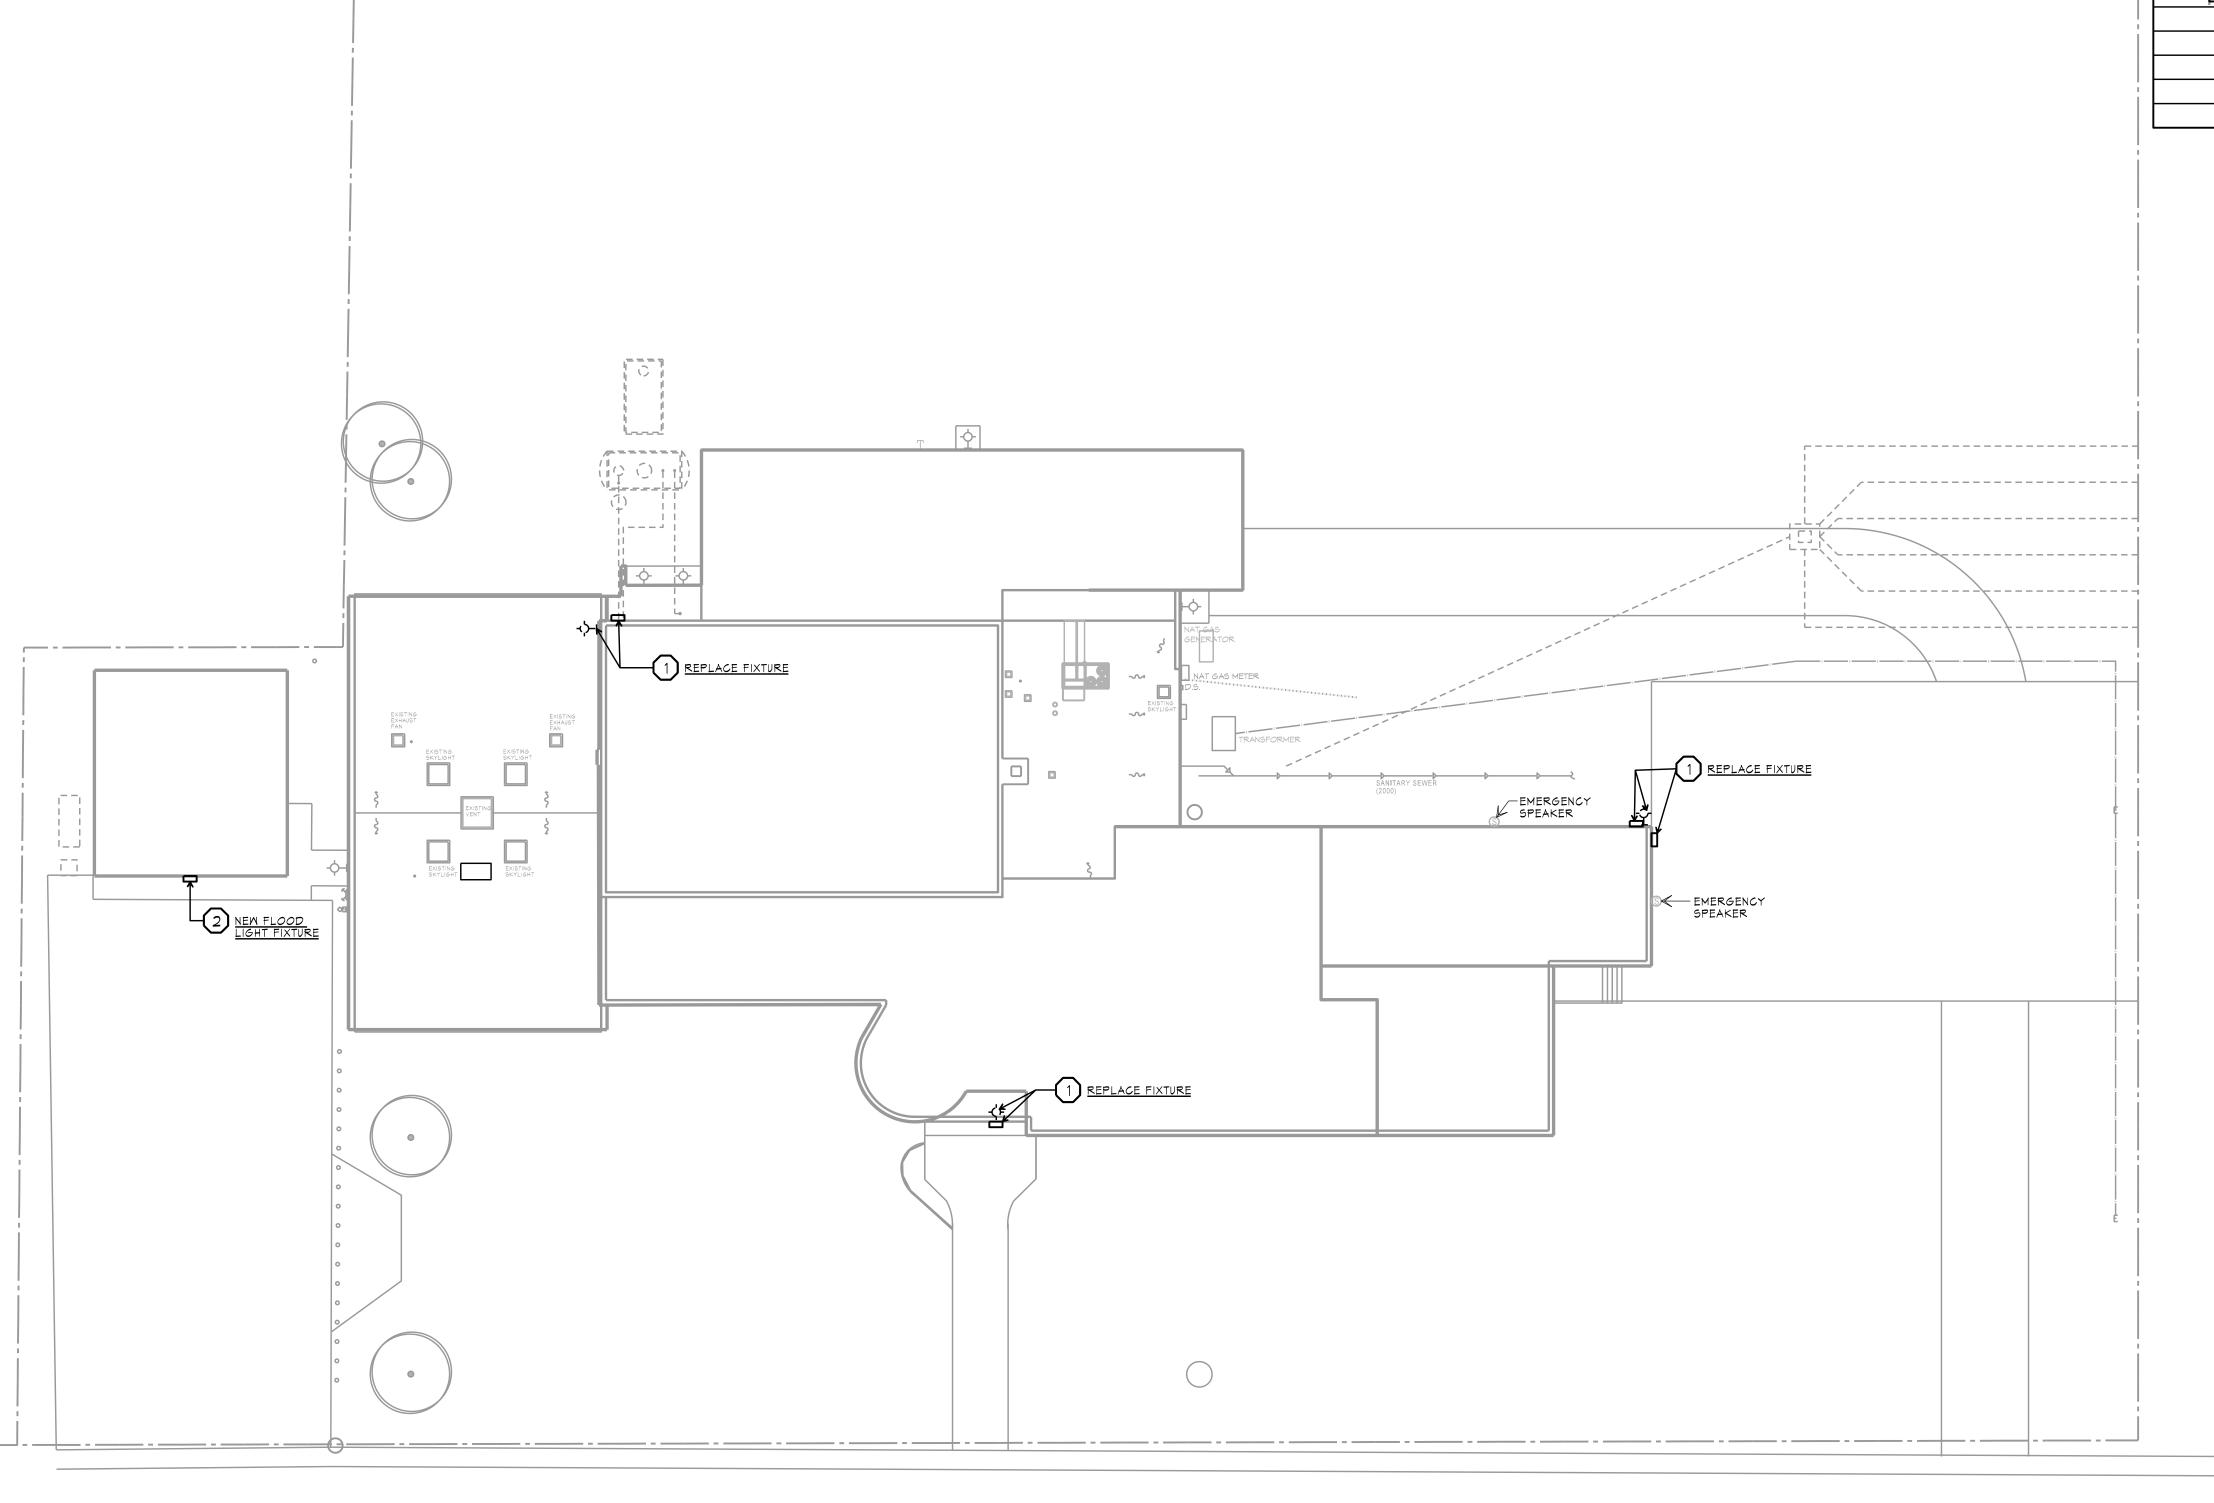

 \downarrow

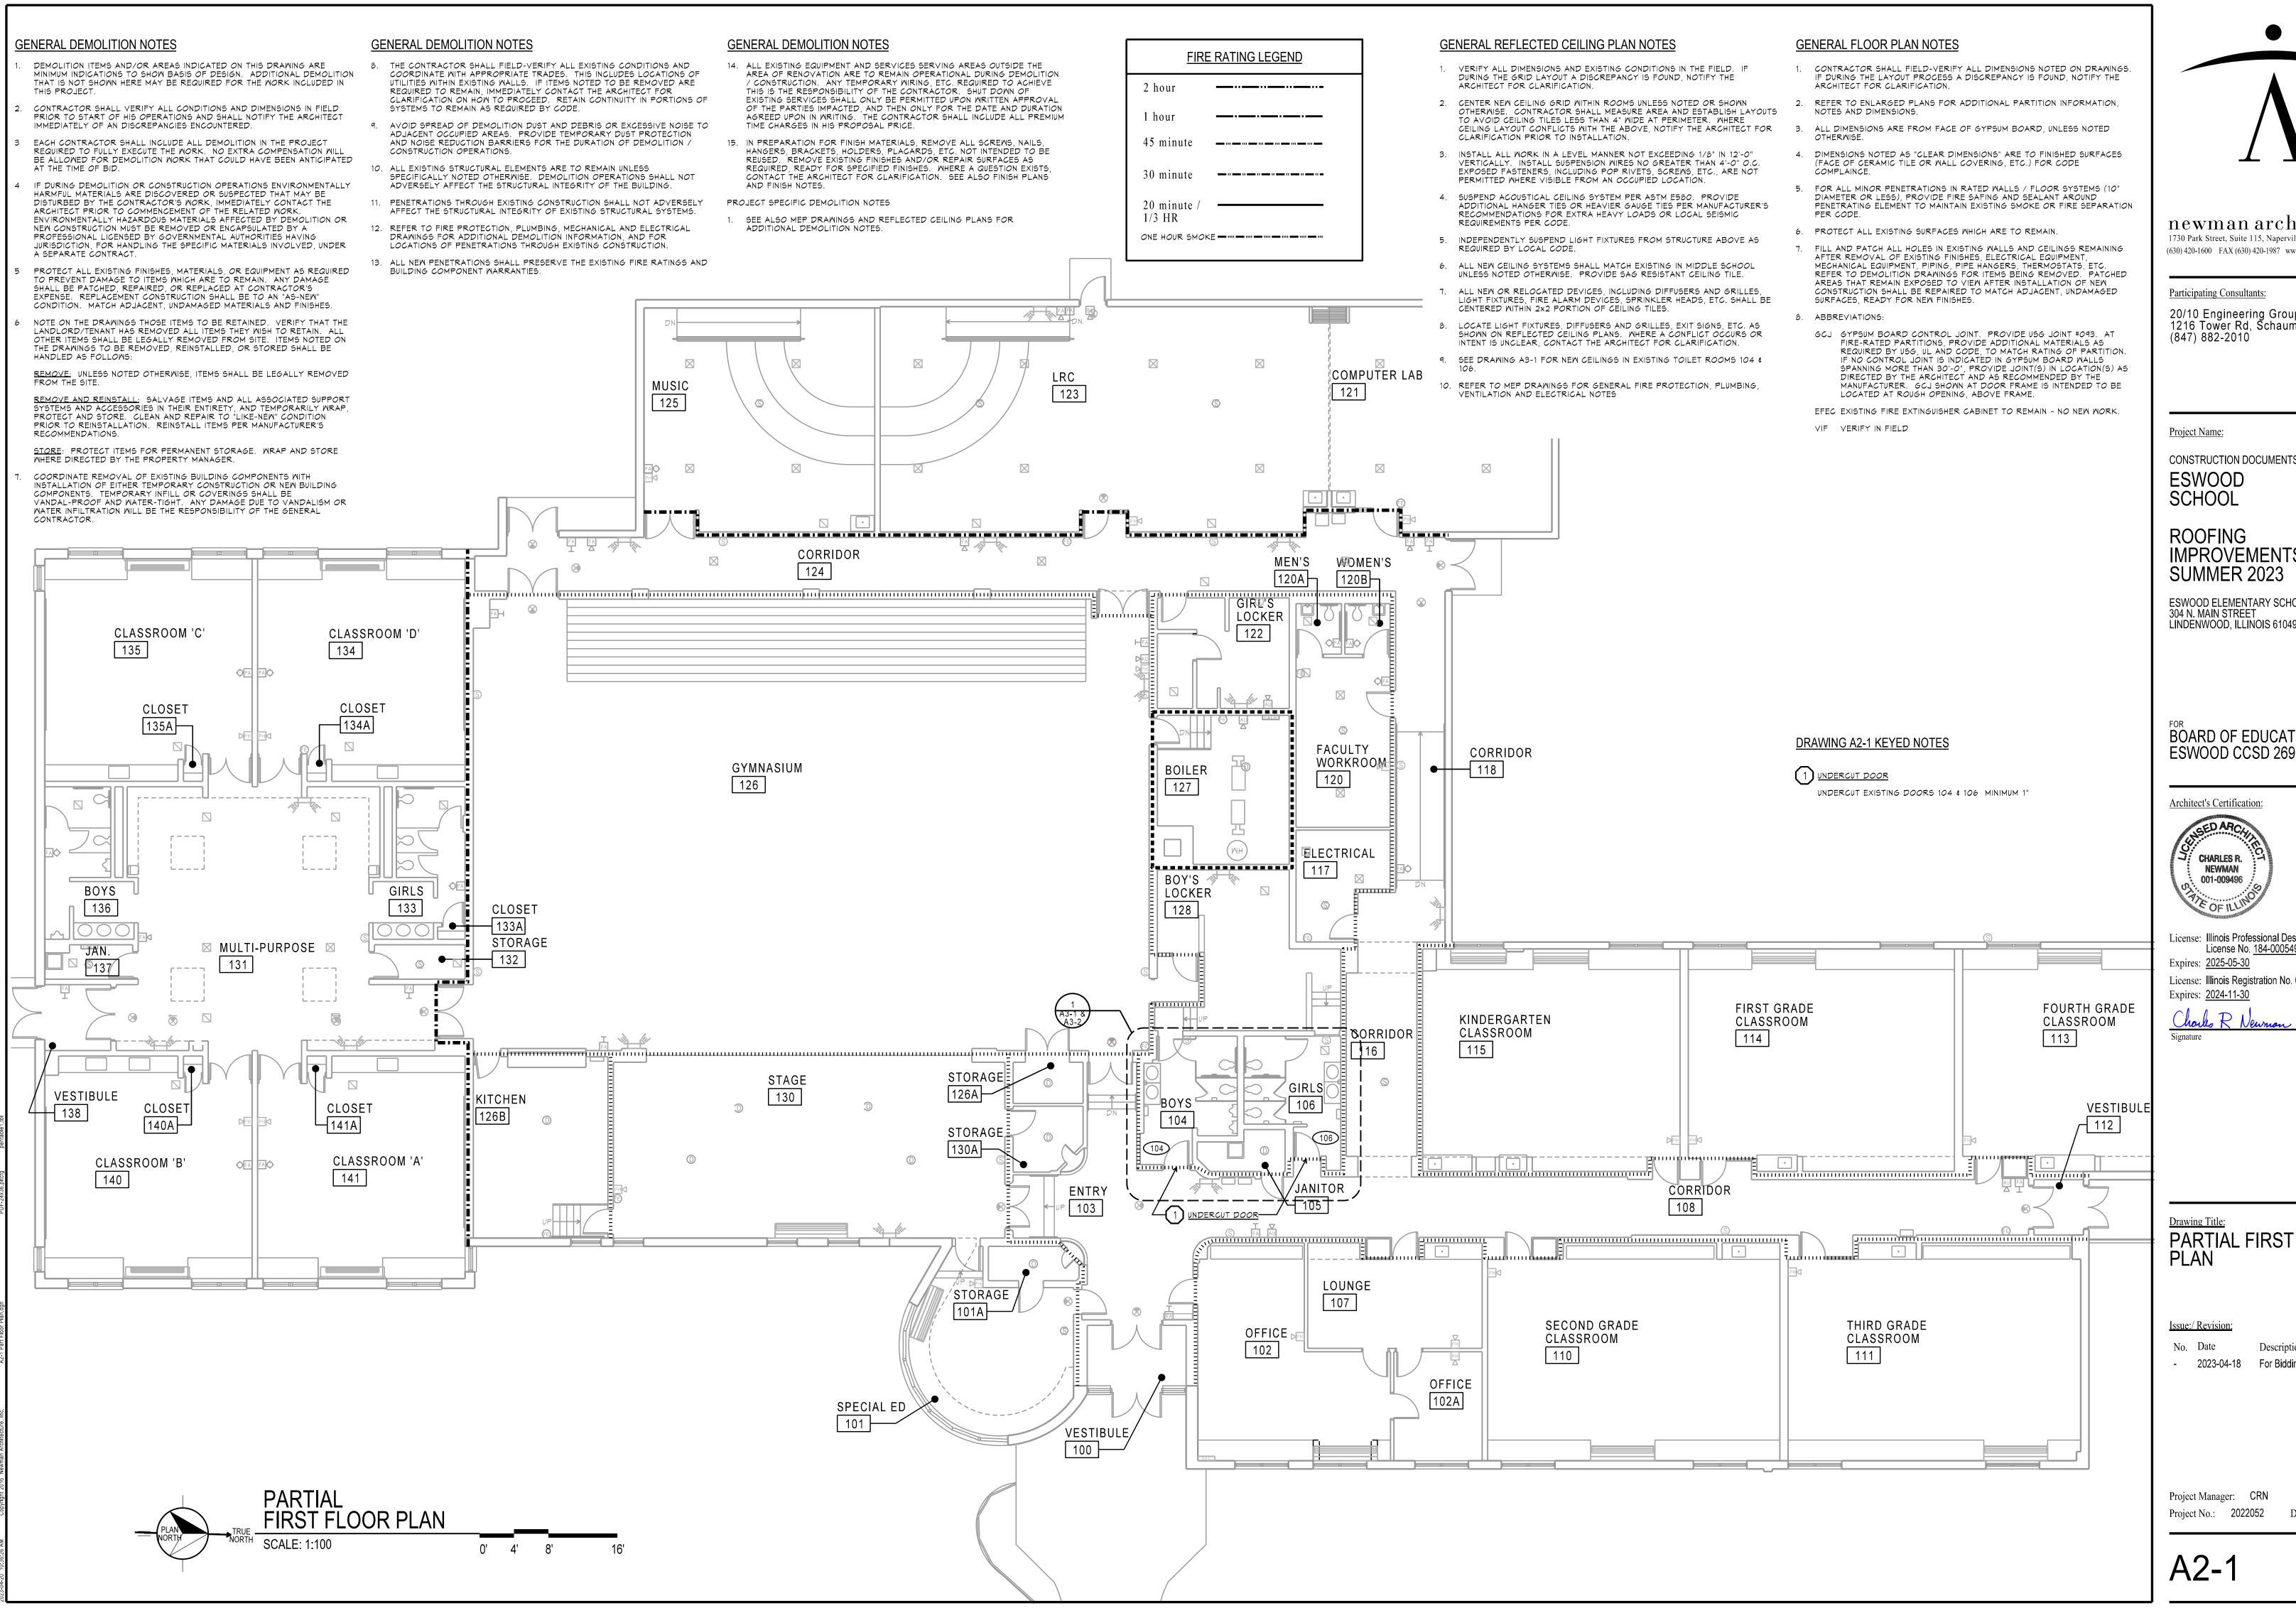

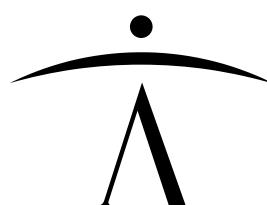

Participating Consultants:

20/10 Engineering Group, LLC 1216 Tower Rd, Schaumburg, IL 60173 (847) 882-2010

CONSTRUCTION DOCUMENTS **ESWOOD**

ROOFING **SUMMER 2023**

ESWOOD ELEMENTARY SCHOOL 304 N. MAIN STREET LINDENWOOD, ILLINOIS 61049

BOARD OF EDUCATION




License: Illinois Professional Design Firm License No. <u>184-000549</u> Expires: <u>2025-05-30</u> License: Illinois Registration No. 001-009496

PARTIAL FIRST FLOOR

Description - 2023-04-18 For Bidding

Project Manager: CRN Project No.: 2022052 Date: 2023-04-18

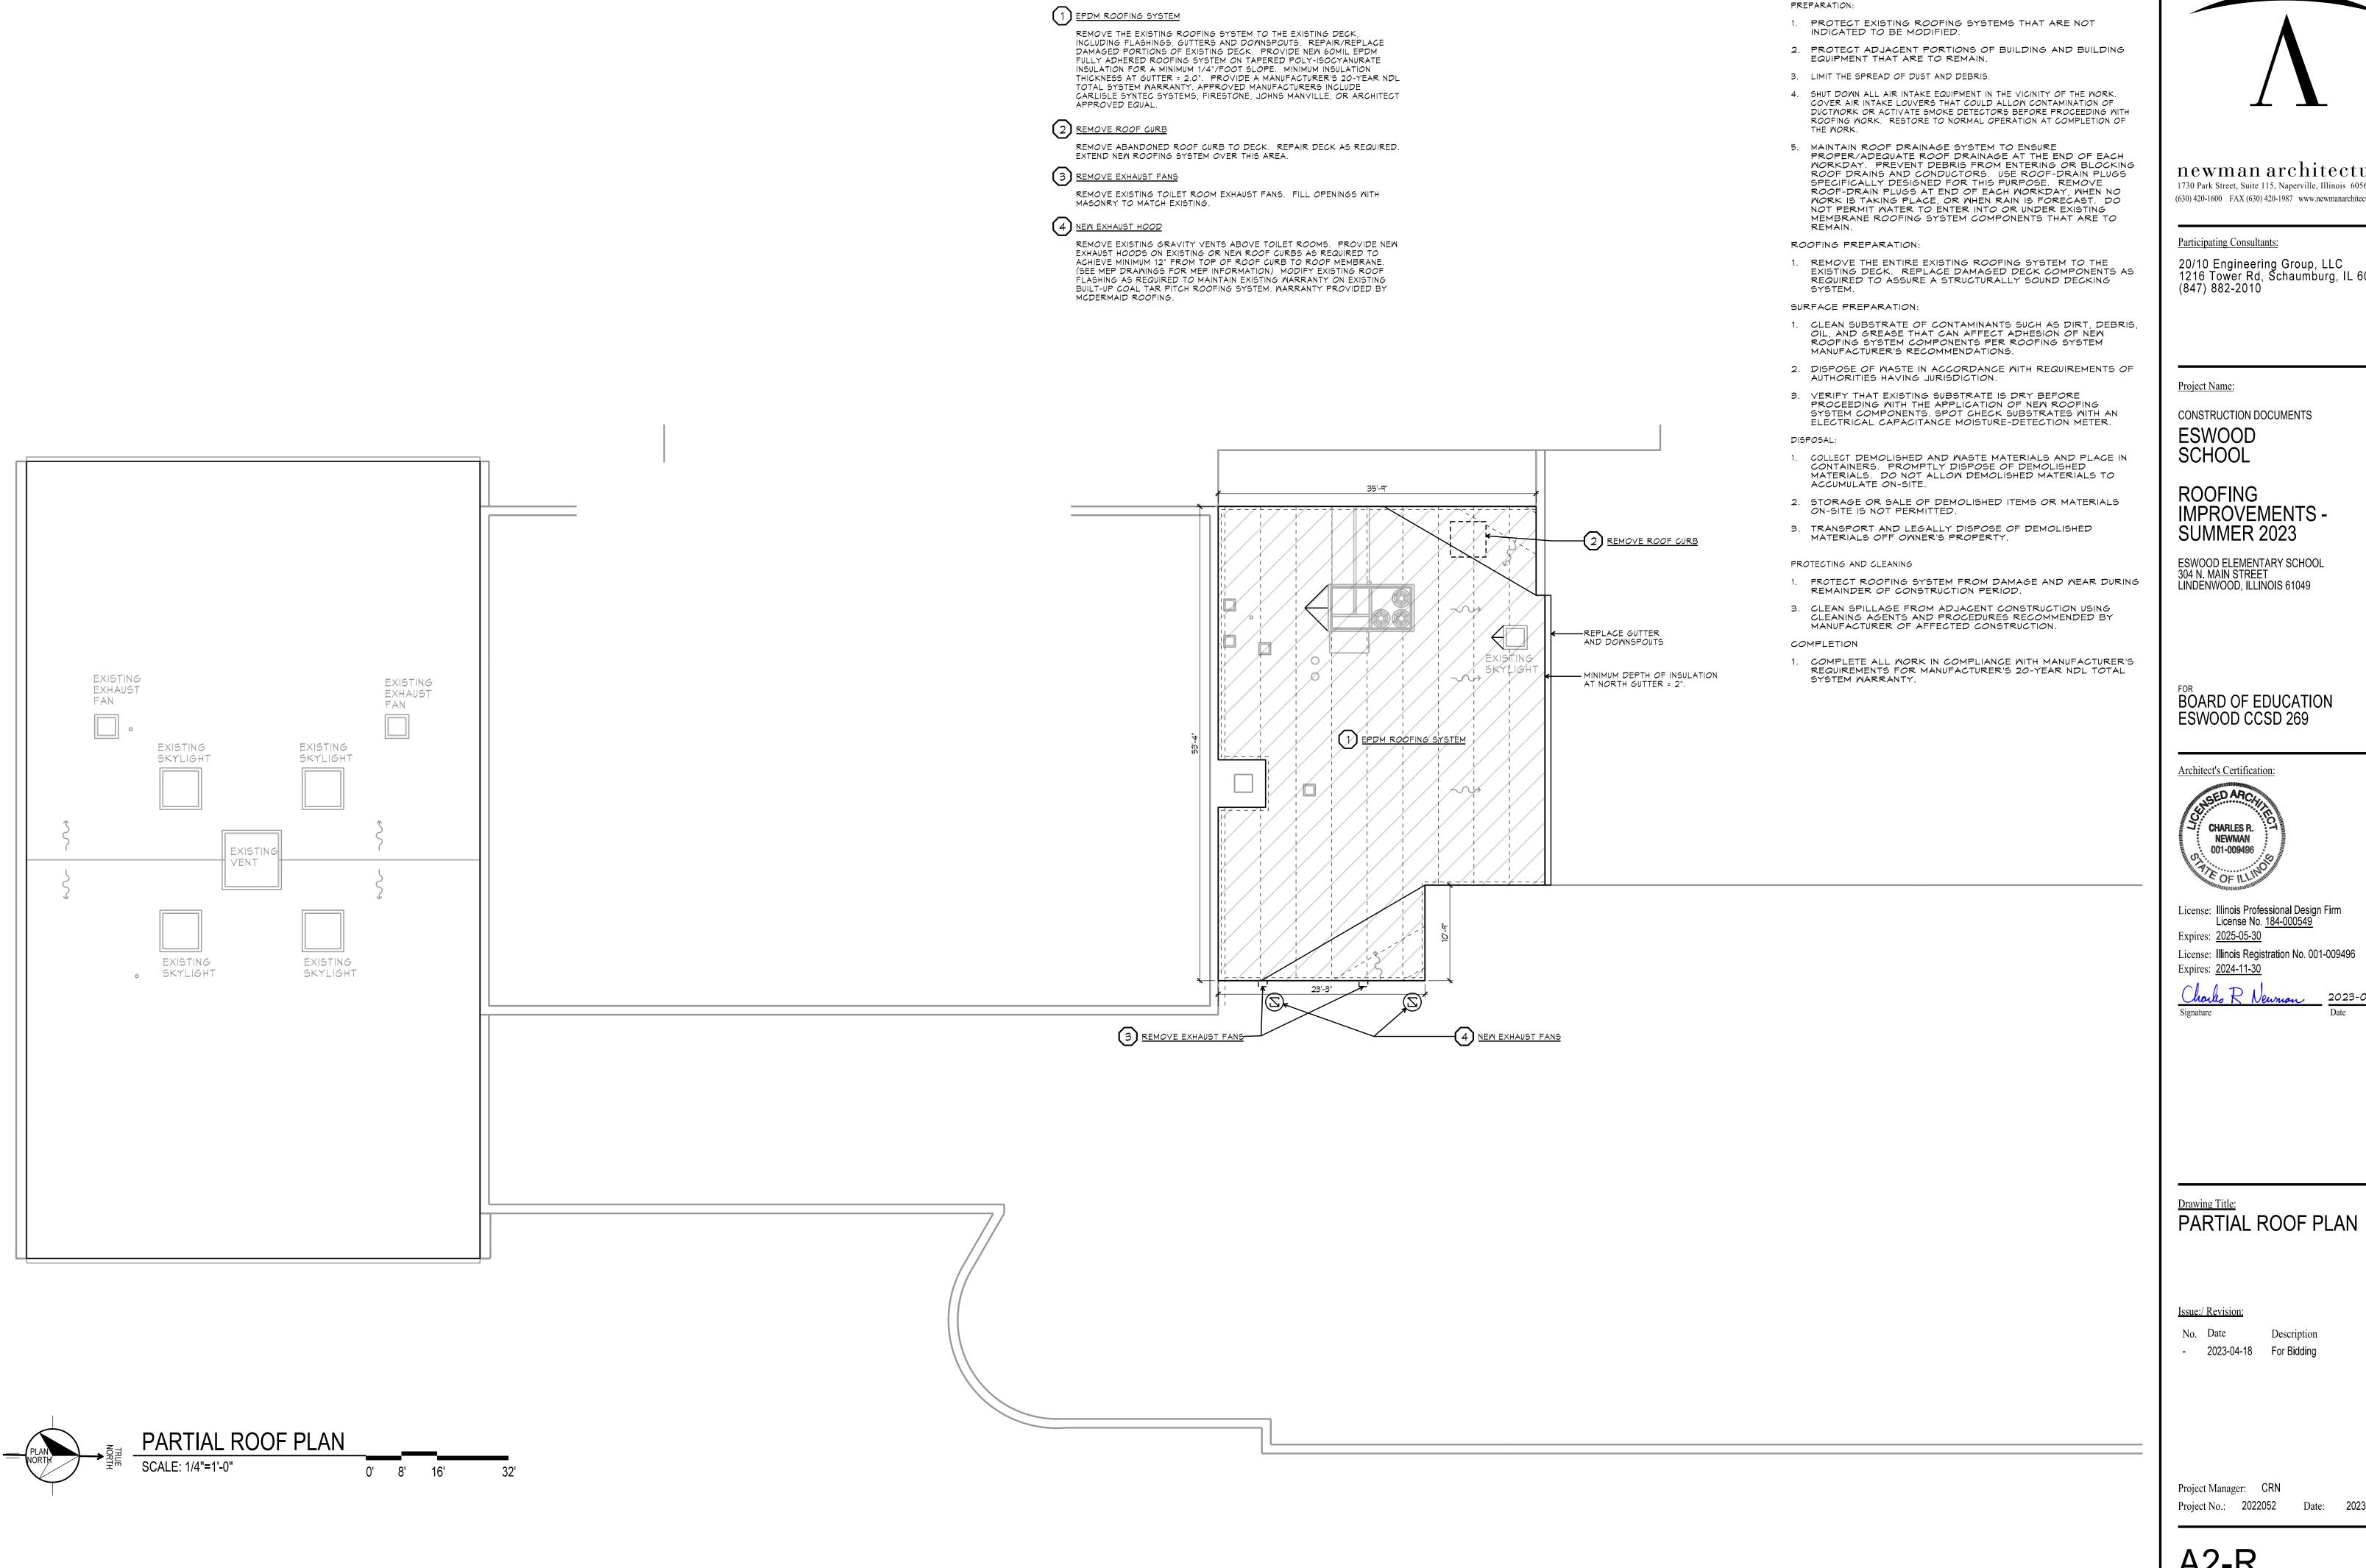

DRAWING A2-R KEYED NOTES



newman architecture 1730 Park Street, Suite 115, Naperville, Illinois 60563-2611 (630) 420-1600 FAX (630) 420-1987 www.newmanarchitecture.com

Participating Consultants:

GENERAL ROOFING IMPROVEMENT NOTES

20/10 Engineering Group, LLC 1216 Tower Rd, Schaumburg, IL 60173 (847) 882-2010

Project Name:

CONSTRUCTION DOCUMENTS **ESWOOD**

ROOFING **SUMMER 2023**

ESWOOD ELEMENTARY SCHOOL 304 N. MAIN STREET LINDENWOOD, ILLINOIS 61049

BOARD OF EDUCATION ESWOOD CCSD 269

Architect's Certification:



License: Illinois Professional Design Firm License No. <u>184-000549</u> Expires: <u>2025-05-30</u> License: Illinois Registration No. 001-009496

Issue:/ Revision:

No. Date Description - 2023-04-18 For Bidding

Project Manager: CRN Project No.: 2022052 Date: 2023-04-18

A2-R

GENERAL FINISH PLAN NOTES

1. SEE DRAWING A8-1 FOR ADDITIONAL GENERAL FINISH NOTES.

GENERAL PAINT NOTES

- CONTRACTOR SHALL FIELD VERIFY EXTENT OF PAINTING AND COLORS REQUIRED. SUBMIT DRAW-DOWNS OF EACH COLOR TO ARCHITECT FOR APPROVAL PRIOR TO INSTALLATION.
- SURFACES NOTED TO BE PAINTED, AS WELL AS FLOORS AND ADJACENT SURFACES, SHALL BE CLEAN. MILDEW, EFFLORESCENCE, AND ALL FOREIGN MATERIAL SHALL BE REMOVED FROM SURFACES BY APPROPRIATE METHODS. PREPARE SURFACES PER MANUFACTURER'S RECOMMENDATIONS.
- 3. PRIME ALL UNFINISHED SURFACES SCHEDULED TO RECEIVE WALLCOVERING OR PAINT PRIOR TO FINISHING AS RECOMMENDED BY MANUFACTURER'S WRITTEN RECOMMENDATIONS FOR EACH SUBSTRATE.
- 4. CONTRACTOR SHALL APPLY ALL PAINT IN ACCORDANCE WITH MANUFACTURER'S RECOMMENDATIONS. ALL COATS MUST BE THOROUGHLY DRY BEFORE APPLYING SUCCEEDING COATS. USE APPLICATIONS AND TECHNIQUES BEST SUITED FOR SUBSTRATE AND TYPE OF MATERIAL BEING APPLIED. PROVIDE TOTAL NUMBER OF COATS AS REQUIRED TO COVER.

FINISH KEY

XX-X DENOTES WALL FINISH U.N.O. XX-X DENOTES FLOOR FINISH

DENOTES WALL BASE XX-X DENOTES FINISH ON SPECIFIC SURFACE

[XX-X] DENOTES FINISH ON REFERENCED SURFACE


PAINT SCHEDULE

- ALL PAINTS SHALL BE LATEX-BASED, AS INDICATED IN FINISH SCHEDULE. HOLLOW METAL DOORS AND FRAMES SHALL BE PAINTED WITH ENAMEL-BASED PAINT. NO SUBSTITUTIONS.
- 2. ALL UNFINISHED WALLBOARD INDICATED TO RECEIVE PAINT OR WALLCOVERING SHALL BE PRIMED WITH ONE (1) COAT SHERWIN-WILLIAMS MULTI-PURPOSE LATEX PRIMER/SEALER.
- ALL UNFINISHED PLYWOOD INDICATED TO RECEIVE PAINT SHALL BE PRIMED WITH ONE (1) COAT SHERWIN-WILLIAMS MULTI-PURPOSE LATEX PRIMER/SEALER.
- 4. ALL UNPAINTED CMU SURFACES INDICATED TO RECEIVE PAINT SHALL RECEIVE ONE COAT OF LATEX BASED INTERIOR/EXTERIOR BLOCK FILLER, THEN LATEX FINISH COATS AS NOTED ABOVE FOR TYPE OF SURFACE.
- ALL UNPRIMED METAL SURFACES INDICATED TO RECEIVE PAINT, INCLUDING LINTELS AND HOLLOW METAL DOORS AND FRAMES, SHALL BE PRIMED WITH ONE (1) COAT RUST-INHIBITING PRIMER (BENJAMIN MOORE ALKYD ENAMEL UNDER BODY PRIMER). EXTERIOR LINTEL, DOOR & FRAME COLOR SHALL MATCH EXISTING EXTERIOR ADJACENT MATERIAL COLOR UNLESS NOTED
- ALL WALLS AND VERTICAL SURFACES OF SOFFITS AND HEADERS INDICATED TO RECEIVE PAINT SHALL RECEIVE MINIMUM OF TWO (2) COATS OF COLOR INDICATED ON PLAN. PAINT FINISH SHALL BE LOW-LUSTER EGGSHELL (OR SATIN) ACCYLLO LATEX, UNLESS NOTED OTHERWISE. PAINT WALLS [PT-1], UNLESS NOTED OTHERWISE.
- 7. ALL CEILINGS OR SOFFITS INDICATED TO RECEIVE PAINT SHALL RECEIVE MINIMUM OF TWO (2) COATS OF COLOR INDICATED ON PLAN. PAINT FINISH
- 8. ALL INTERIOR HOLLOW METAL DOORS AND FRAMES INDICATED TO RECEIVE PAINT SHALL BE PAINTED AS NOTED IN FINISH SCHEDULE. SEE FINISH SCHEDULE ON DRAWING A8-1.
- ALL MISCELLANEOUS METAL SURFACES SHOWN TO BE PAINTED SHALL RECEIVE MINIMUM OF TWO (2) COATS, ALKYD ENAMEL PAINT, FINISH SEMI-GLOSS, COLOR AS INDICATED.

SHALL BE "FLAT" UNLESS NOTED OTHERWISE.

- 10. PAINTS AND COATINGS SHALL COMPLY WITH THE FOLLOWING VOC LIMIT (GRAMS/LITER LESS WATER): - ARCHITECTURAL PAINTS, PRIMERS AND COATINGS - GREEN SEAL STANDARD GS-11, 1993.
- FLATS: 50 G/L - NON-FLATS: 150 G/L
- ANTI-RUST PAINTS GREEN SEAL STANDARD GC-03, 1997
- APPLIED TO FERROUS METAL: 250 G/L
 CLEAR WOOD FINISHES, STAINS, SEALERS, SHELLACS SCAQMD RULE 113, - CLEAR MOOD FINISH:
- VARNISH: 350 G/L - LACQUER: 550 G/L
- WATERPROOF SEALERS: 250 G/L - SANDING SEALERS: 275 G/L
- OTHER SEALERS: 200 G/L - STAINS: 250 G/L
- 11. PROVIDE PAINTS AS NOTED ON THE FINISH SCHEDULE. PAINTS MAY BE COLOR MATCHED. ACCEPTABLE MANUFACTURERS ARE AS FOLLOWS: BENJAMIN MOORE, DUNN EDWARDS, GLIDDEN, SHERWIN-WILLIAMS, ARCHITECT APPROVED EQUAL.

				FINISH S	CHEDULE		
ΓAG	LOCATION	MFG.	PATTERN/CO	LOR		SIZE	REMARKS
ACT-1 PT-1	ALL AREAS MATCH EXISTING	ARMSTRONG SHERWIN WILLIAMS	MODEL: 171 COLOR: WHI GRID: 15/16 FINISH: MAT	TE "		24" x 24"	NON-DIRECTIONAL SAG RESISTANT CEILING TILE 30-YEAR WARRANTY MATCH SOUTH WING CEILING SYSTEM - VERIFY IN FIELD FOR TOUCHUP AS REQUIRED
				ABBREV	IATIONS		
RB - RU	COUSTIC CEILING TILE BBER BASE INDOW COVERINGS	C - CARPET RVS - RIGID	VINYL SHEET	CB - CERAMIC BASE SC - SEALED CONCRETE	CT - CERAMIC TILE SS - SOLID SUFACE		VT - LUXURY VINYL TILE PT - PAINT /CT - VINYL COMPOSITION FLOOR TILE

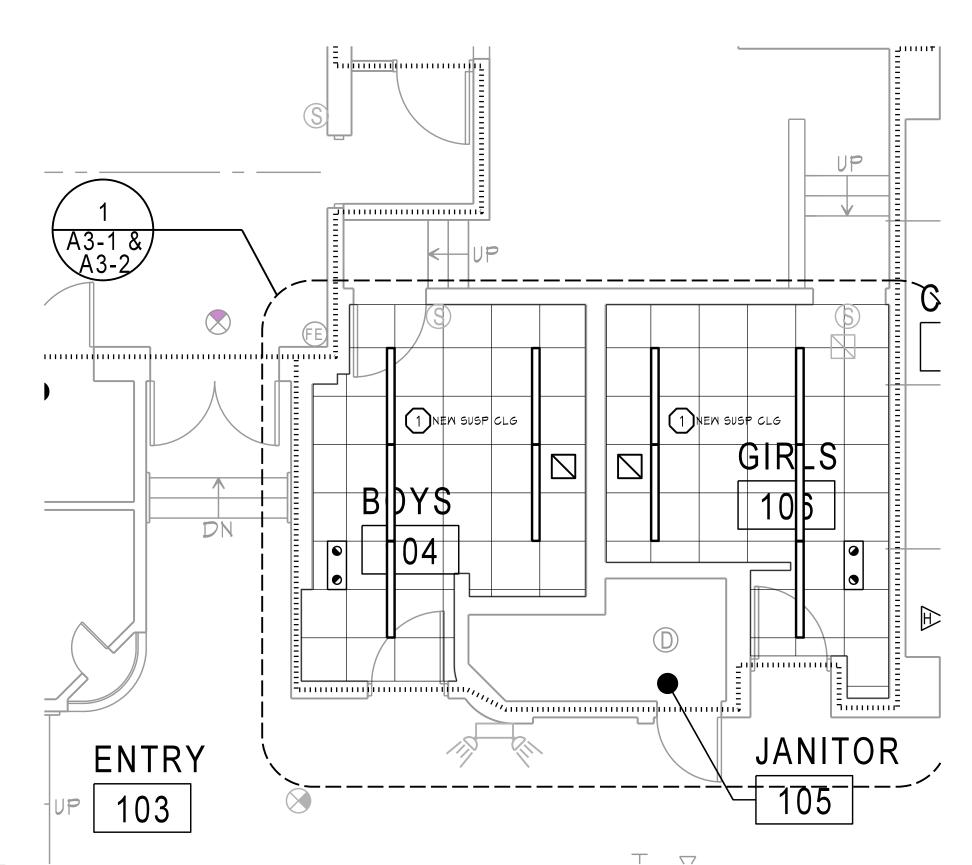




DRAWING A3-1 KEYED NOTES

1 NEW SUSP CLG

PROVIDE A NEW SUSPENDED CEILING. MATCH GRID AND CEILING WITH CEILINGS IN MIDDLE SCHOOL. VERIFY IN FIELD. MOUNT THE CEILING AS HIGH AS POSSIBLE, ALLOWING SPACE FOR SERVICING LIGHTING AND EXISTING OR NEW EQUIPMENT ABOVE CEILING. PROVIDE NEW LIGHT FIXTURES, EMERGENCY LIGHT FIXTURES, RADIANT PANELS AND EXHAUST GRILLES IN NEW CEILINGS. DROP EXISTING SPEAKERS TO BELOW NEW CEILING. SEE MEP DRAWINGS.

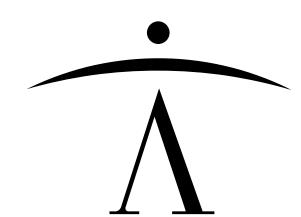

newman architecture 1730 Park Street, Suite 115, Naperville, Illinois 60563-2611 (630) 420-1600 FAX (630) 420-1987 www.newmanarchitecture.com

Participating Consultants:

20/10 Engineering Group, LLC 1216 Tower Rd, Schaumburg, IL 60173 (847) 882-2010

Project Name:

CONSTRUCTION DOCUMENTS **ESWOOD**

ROOFING **IMPROVEMENTS** -**SUMMER 2023**

ESWOOD ELEMENTARY SCHOOL 304 N. MAIN STREET LINDENWOOD, ILLINOIS 61049

BOARD OF EDUCATION ESWOOD CCSD 269

Architect's Certification:



License: Illinois Professional Design Firm License No. <u>184-000549</u> Expires: <u>2025-05-30</u> License: Illinois Registration No. 001-009496

Expires: <u>2024-11-30</u>

Drawing Title:


ENLARGED PLANS & REFLECTED CEILING PLANS & DETAILS

Issue:/ Revision:


No. Date Description - 2023-04-18 For Bidding

Project Manager: CRN Project No.: 2022052 Date: 2023-04-18

A3-1

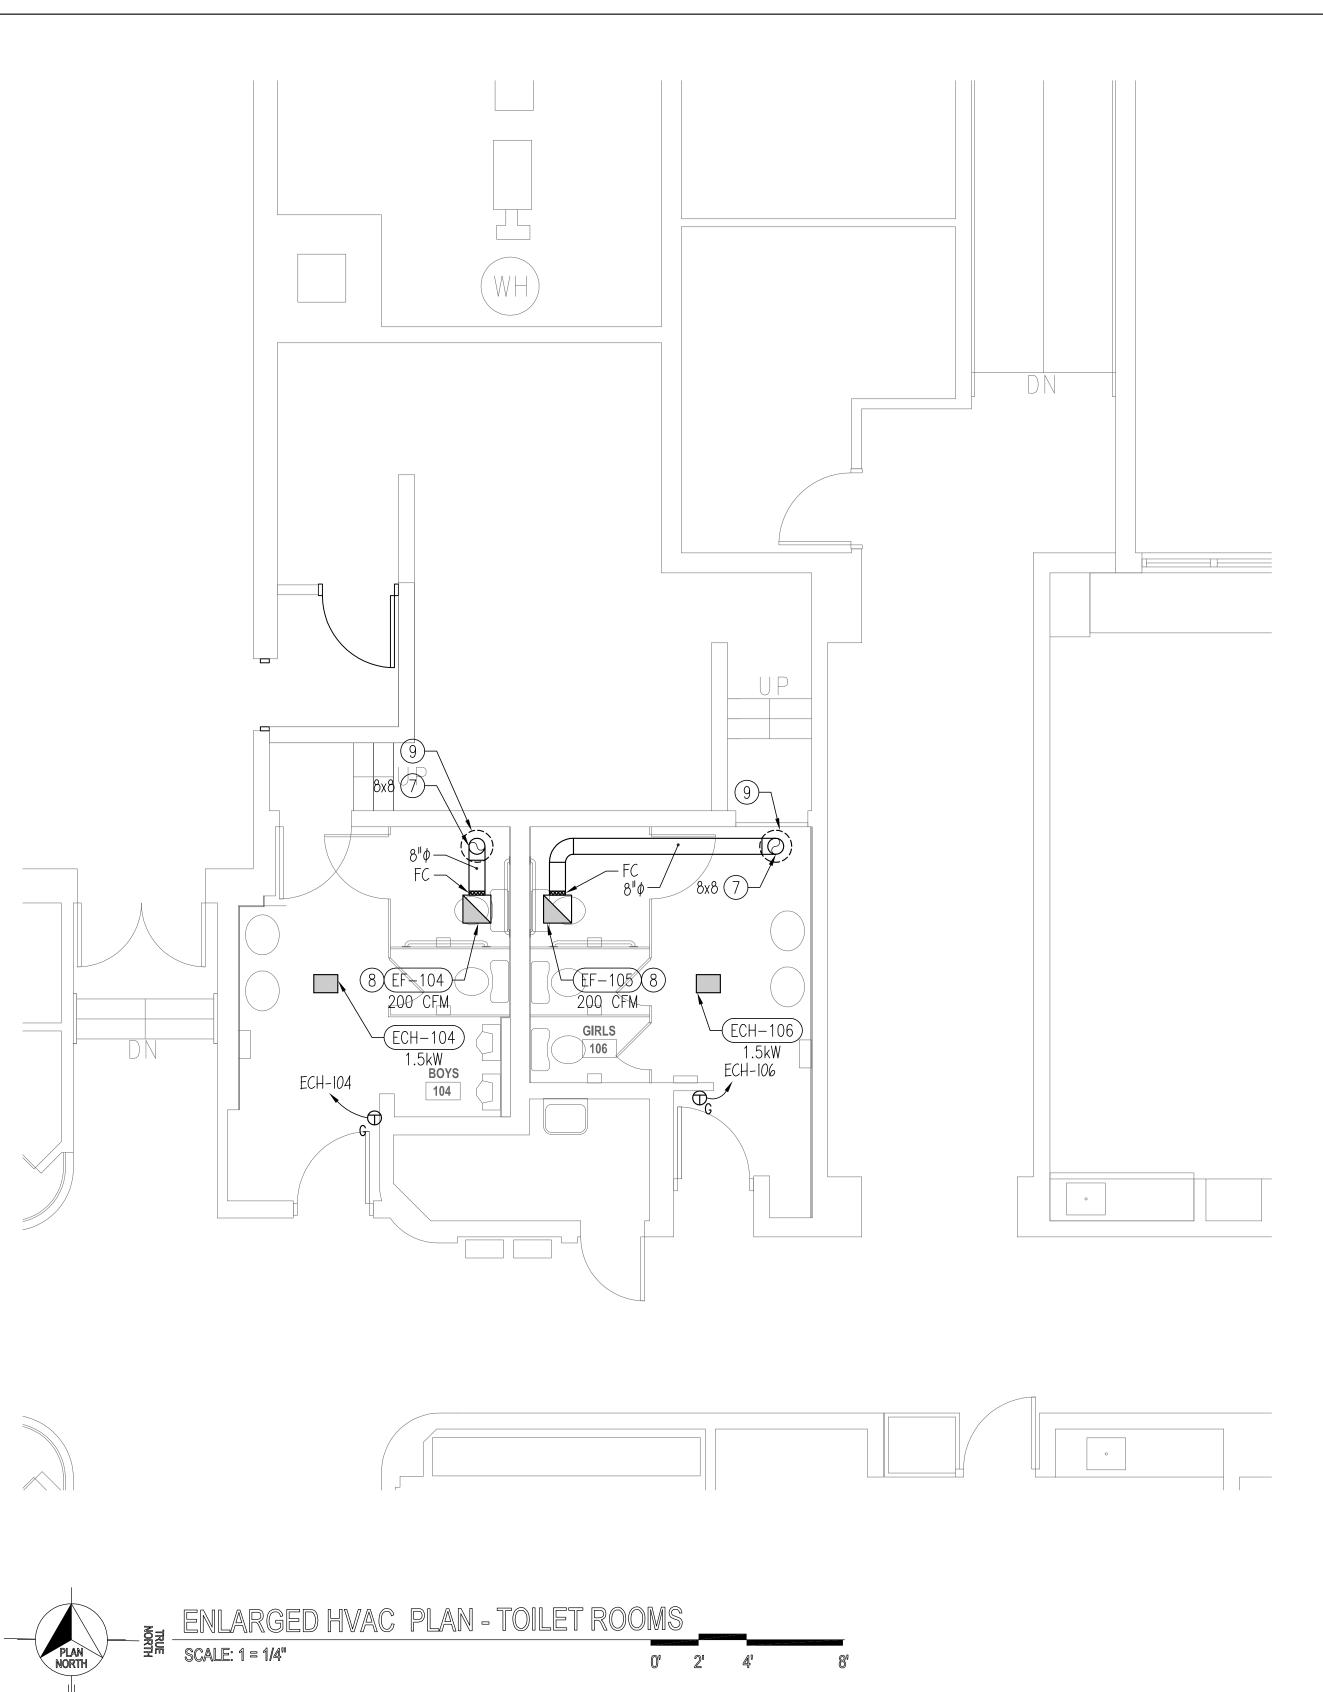



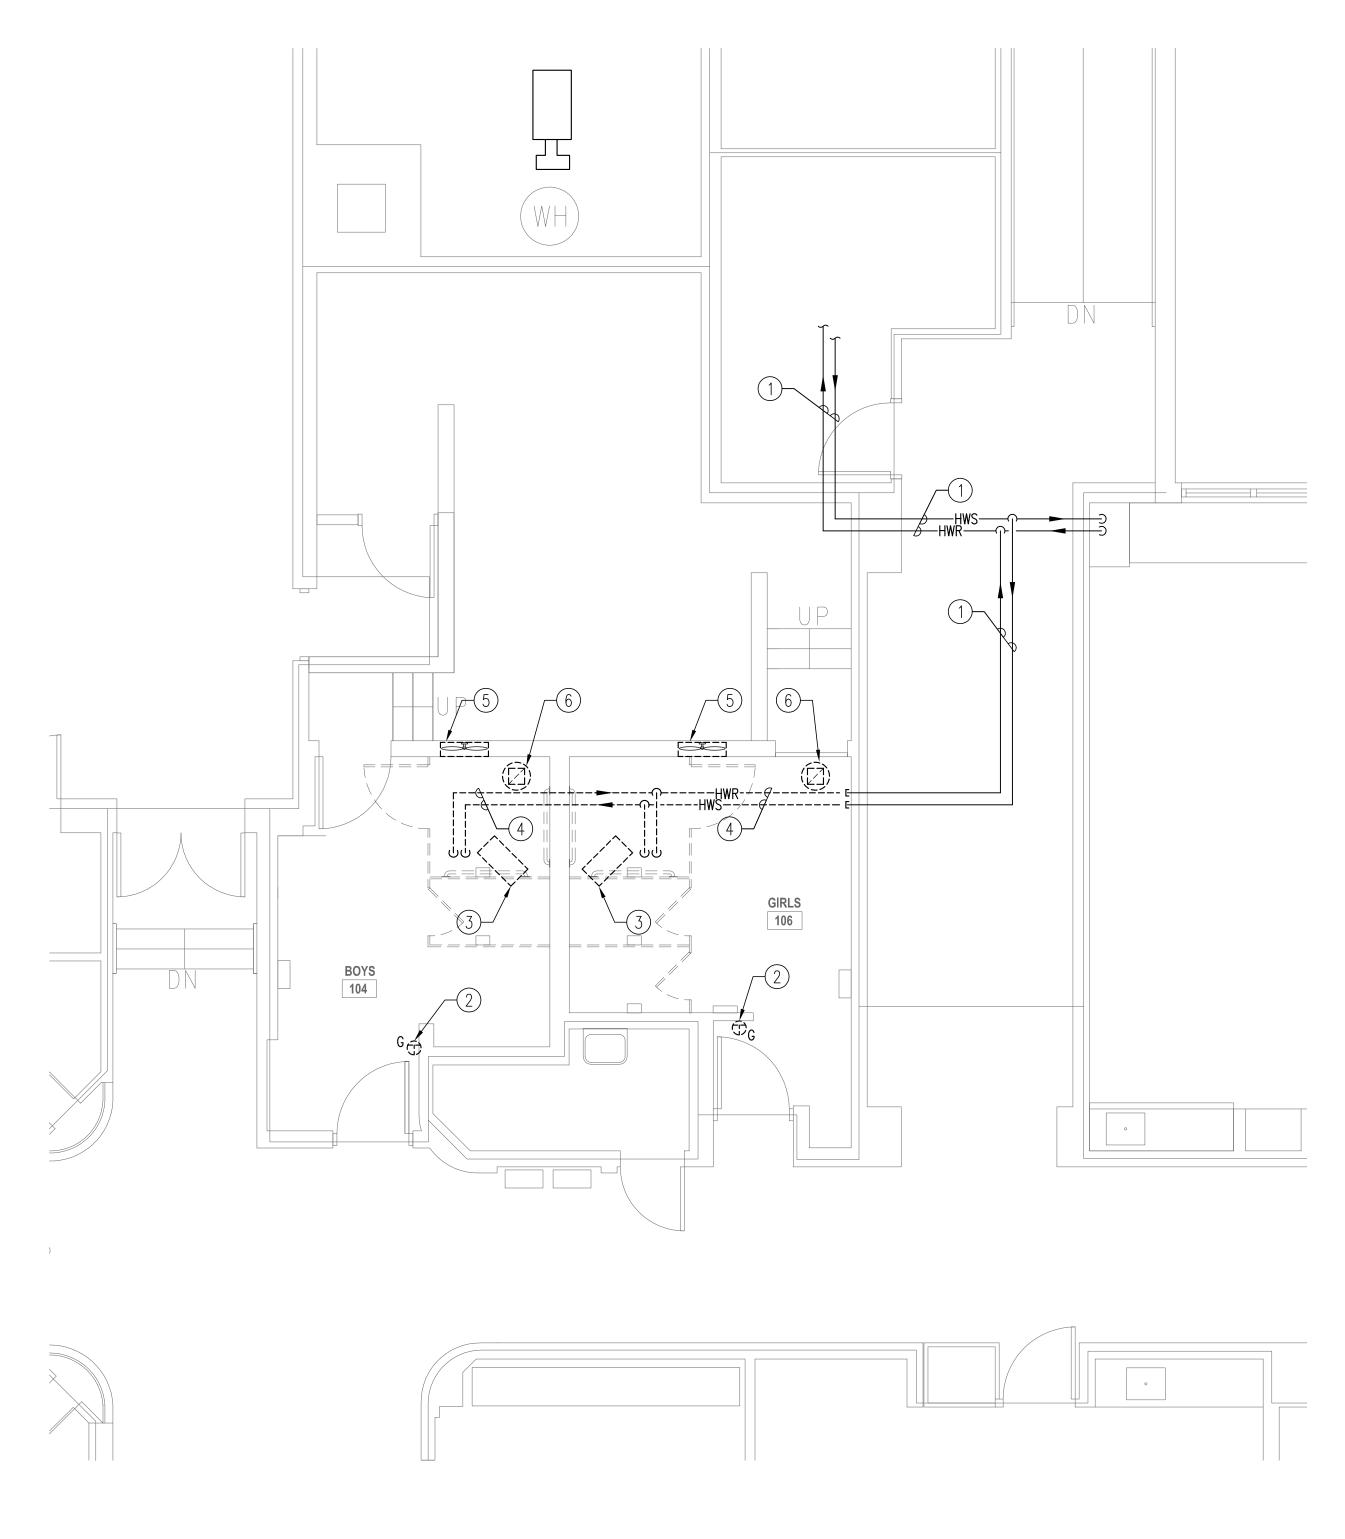




DRAWING NOTES: (TYPICAL FOR THIS DRAWING ONLY.)

- 1) EXISTING PIPING AND VALVING TO REMAIN.
- 2 REMOVE EXISTING THERMOSTAT INCLUDING ALL ASSOCIATED CONDUIT, WIRING, PNEUMATIC TUBING, ETC. LOCATED ABOVE ANY ACCESSIBLE CEILING BETWEEN THERMOSTAT AND THE UNIT IT CONTROLS. PROVIDE BLANK COVER PLATE OVER ALL ABANDONED JUNCTION BOXES IN WALLS THAT ARE TO REMAIN.
- 3 REMOVE SUSPENDED UNIT HEATER AND ALL ASSOCIATED HANGERS, PIPING, VALVING AND CONTROLS.
- 4 REMOVE ALL PIPING, VALVING, HANGERS, INSULATION, ETC. SHOWN DASHED.
- (5) REMOVE EXISTING WALL PROPELLER EXHAUST FAN AND ASSOCIATED WALL CAP, CONTROLS, ETC. PATCH WALL TO MATCH EXISTING.
- 6 REMOVE EXISTING ATTIC VENT ON ROOF AND ALL ASSOCIATED DUCTWORK, GRILLES, INSULATION, ETC. MODIFY EXISTING ROOF OPENING AS REQUIRED FOR NEW EXHAUST DUCTWORK UP THRU ROOF. SEE NEW WORK PLAN ON THIS SHEET FOR MORE INFORMATION.

- 7 MODIFY EXISTING ROOF OPENING AS REQUIRED TO ACCOMMODATE NEW EXHAUST DUCTWORK OF SIZE INDICATED THRU ROOF.
- 8 STEEL ROD SUSPEND FROM STRUCTURE ABOVE WITH NEOPRENE VIBRATION ISOLATORS.
- 9) ROOF HOOD FURNISHED WITH EXHAUST FAN.

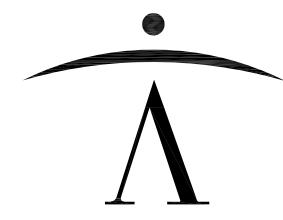

newman architecture 1730 Park Street, Suite 115, Naperville, Illinois 60563-2611 (630) 420-1600 FAX (630) 420-1987 www.newmanarchitecture.com

Mechanical - Electrical Engineers 1216 Tower Road Schaumburg, Illinois 60173 847.882.2010 Fax 847.882.2201

Project Name:

CONSTRUCTION DOCUMENTS **ESWOOD** SCHOOL

ROOFING IMPROVEMENTS -SUMMER 2023

ESWOOD ELEMENTARY SCHOOL 304 N. MAIN STREET LINDENWOOD, ILLINOIS 61049

BOARD OF EDUCATION ESWOOD CCSD 269

Engineer's Certification:



License: Illinois Professional Design Firm License No. <u>184-004110</u>
Expires: <u>2023-04-30</u>

License: Illinois Registration No. 062-040860
Expires: 2023-11-30


Drawing Title:
ENLARGED HVAC
PLANS


Issue:/ Revision:

No. Date Description - 2023-04-18 ISSUED FOR BID

Project Manager: CRN

Project No.: 2022052 Date: 2023-04-18

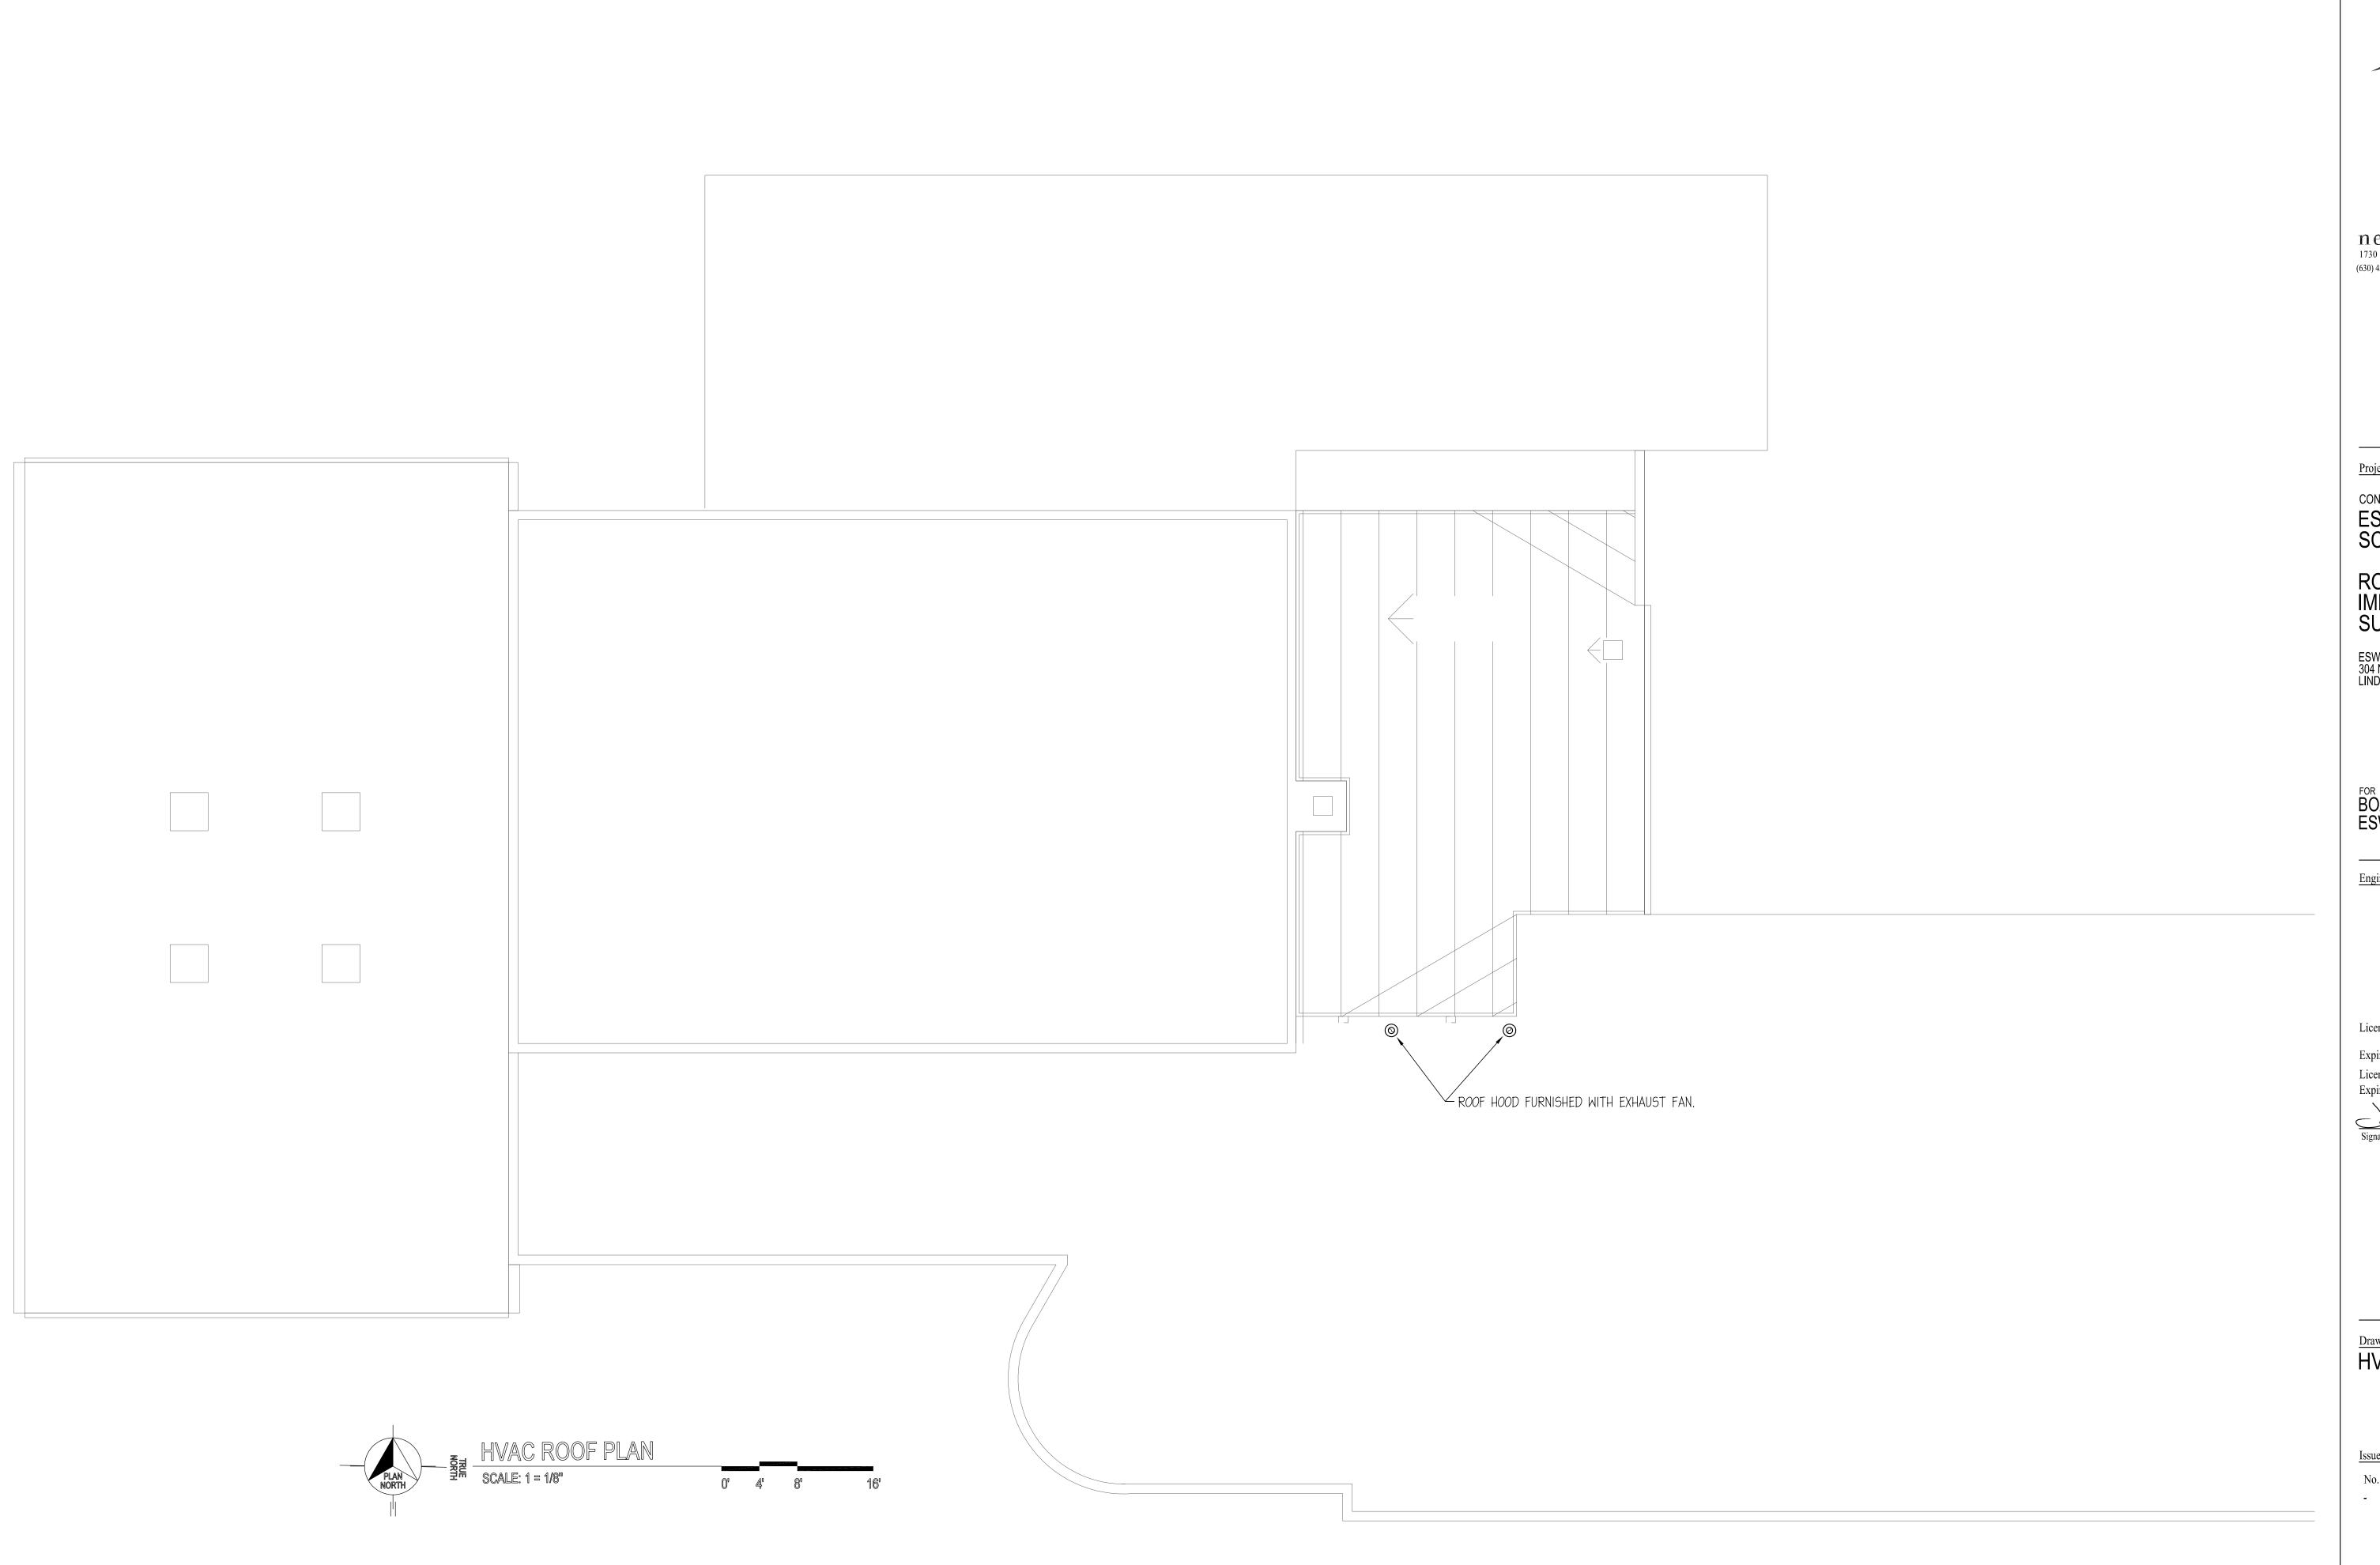

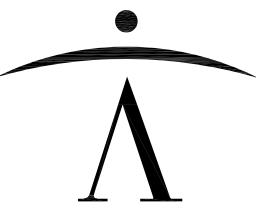

Mechanical - Electrical Engineers 1216 Tower Road Schaumburg, Illinois 60173 847.882.2010 Fax 847.882.2201

Project Name:

CONSTRUCTION DOCUMENTS **ESWOOD** SCHOOL

ROOFING IMPROVEMENTS -SUMMER 2023

ESWOOD ELEMENTARY SCHOOL 304 N. MAIN STREET LINDENWOOD, ILLINOIS 61049

BOARD OF EDUCATION ESWOOD CCSD 269

Engineer's Certification:



License: Illinois Professional Design Firm
License No. 184-004110

Expires: 2023-04-30

License: Illinois Registration No. 062-040860

Expires: 2023-11-30

Signature 2023-04-18

Date

Drawing Title:
HVAC ROOF PLAN

Issue:/ Revision:

No. Date Description - 2023-04-18 ISSUED FOR BID

Project Manager: CRN Project No.: 2022052 Date: 2023-04-18

	EXHAUST FAN SCHEDULE																
EQUIPMENT	LOCATION	AREA	MANUFACTURER	MODEL	TYPE	רטווער	MIN. WHEEL	CFM	SP		FAN RPM	BHP	MOTOR				NOTES
TAG	LUCATION	SERVED	MANUFACTURER	MODEL	IIFE	DRIVE	DIA (IN.)	CFIVI	(IN.)				HP	RPM	PHASE	VOLT	NOTES
EF-104	TOILET 104	TOILET 104	GREENHECK	SPA-290	CEILING MOUNTED FAN	DIRECT		200	0.5	3.5	1156	11	81 WATTS	1350	1	120	1,2,3
EF-105	TOILET 105	TOILET 105	GREENHECK	SPA-290	CEILING MOUNTED FAN	DIRECT		200	0.5	3.5	1156		81 WATTS	1350	1	120	1,2,3

NOTES: I. OTHER ACCEPTABLE MANUFACTURERS: COOK, CARNES, ACME.

2. PROVIDE THE FOLLOWING OPTIONS: GRAVITY BACKDRÁFT DAMPER, DISCONNECT


SWITCH OR PLUG, AND NEOPRENE VIBRATION ISOLATION SUSPENSION KIT.

3. PROVIDE ROOF DISCHARGE ACCESSORY 'GRSR-08' WITH MANUFACTURER'S STANRARD CURB.

ELECTRIC CEILING HEATER SCHEDULE												
EQUIP. TAG	LOCATION	AREA SERVICE	MANUFACTURER	MODEL	TYPE	SIZE (LxWxD)	CFM	KW	AMPS	PHASE	VOLT	NOTES
ECH-104	TOILET 104	TOILET 104	MARKEL	3000	RECESSED CEILING	12 1/4x9 1/4 x3 5/8	100	1.5	7.2	1	208	1,2,3,4
ECH-105	TOILET 105	TOILET 105	MARKEL	3000	RECESSED CEILING	12 1/4x9 1/4 x3 5/8	100	1.5	7.2	1	208	1,2,3,4

2. WALL MOUNT THERMOSTAT WITH GUARD.


4. MOUNTING KIT TO MATCH MOUNTING REQUIREMENTS.

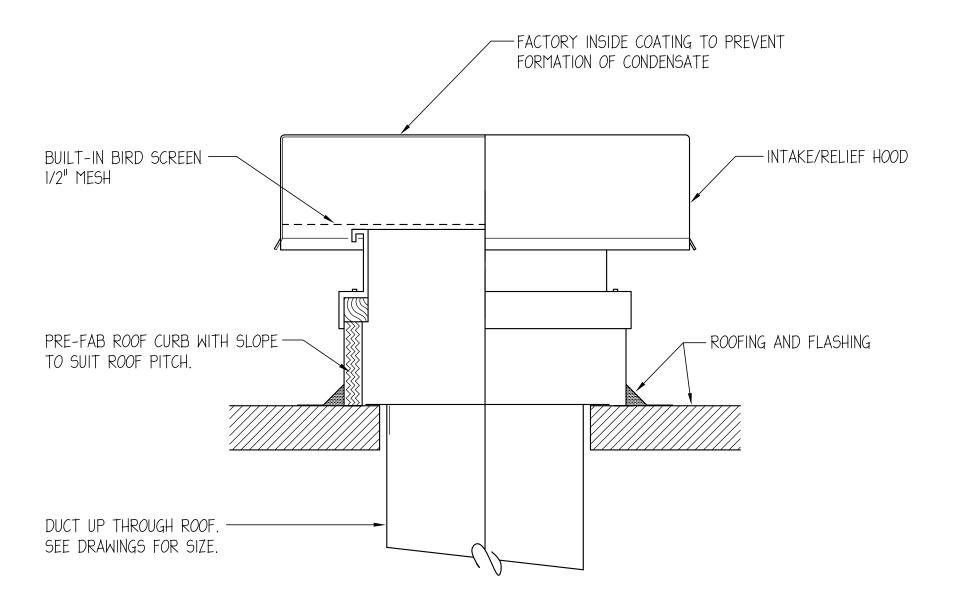


RELIEF HOOD INSTALLATION DETAIL

NO SCALE

HVAC SYMBOLS AND ABBREVIATIONS

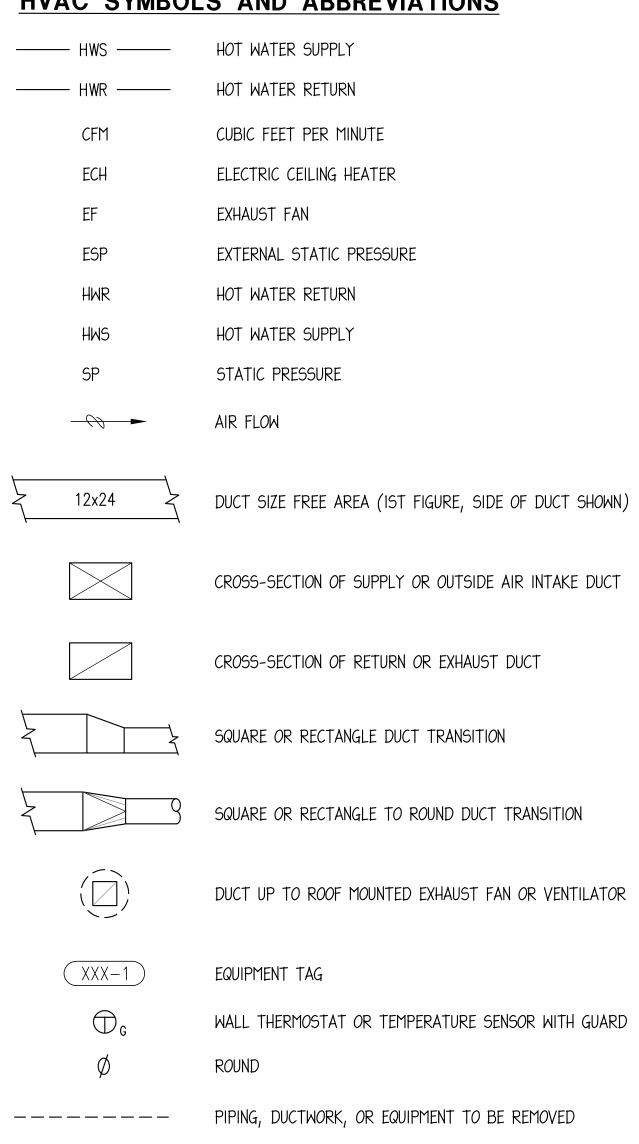

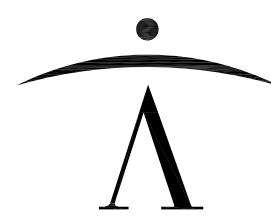

newman architecture 1730 Park Street, Suite 115, Naperville, Illinois 60563-2611 (630) 420-1600 FAX (630) 420-1987 www.newmanarchitecture.com

> Mechanical - Electrical Engineers 1216 Tower Road Schaumburg, Illinois 60173 847.882.2010 Fax 847.882.2201

Project Name:

CONSTRUCTION DOCUMENTS **ESWOOD** SCHOOL

ROOFING IMPROVEMENTS -SUMMER 2023

ESWOOD ELEMENTARY SCHOOL 304 N. MAIN STREET LINDENWOOD, ILLINOIS 61049

BOARD OF EDUCATION ESWOOD CCSD 269

Engineer's Certification: C. CHAME 40860 REGISTERED PROFESSIONAL ENGINEER OF ZZINOIS

License: Illinois Professional Design Firm License No. 184-004110
Expires: 2023-04-30

License: Illinois Registration No. 062-040860

Expires: <u>2023-11-30</u> Cionatura 2023-04-18
Date

Drawing Title:
HVAC SCHEDULES,
SYMBOLS, AND DETAILS


Issue:/ Revision:


No. Date Description - 2023-04-18 ISSUED FOR BID

Project Manager: CRN

Project No.: 2022052 Date: 2023-04-18

HV3-1

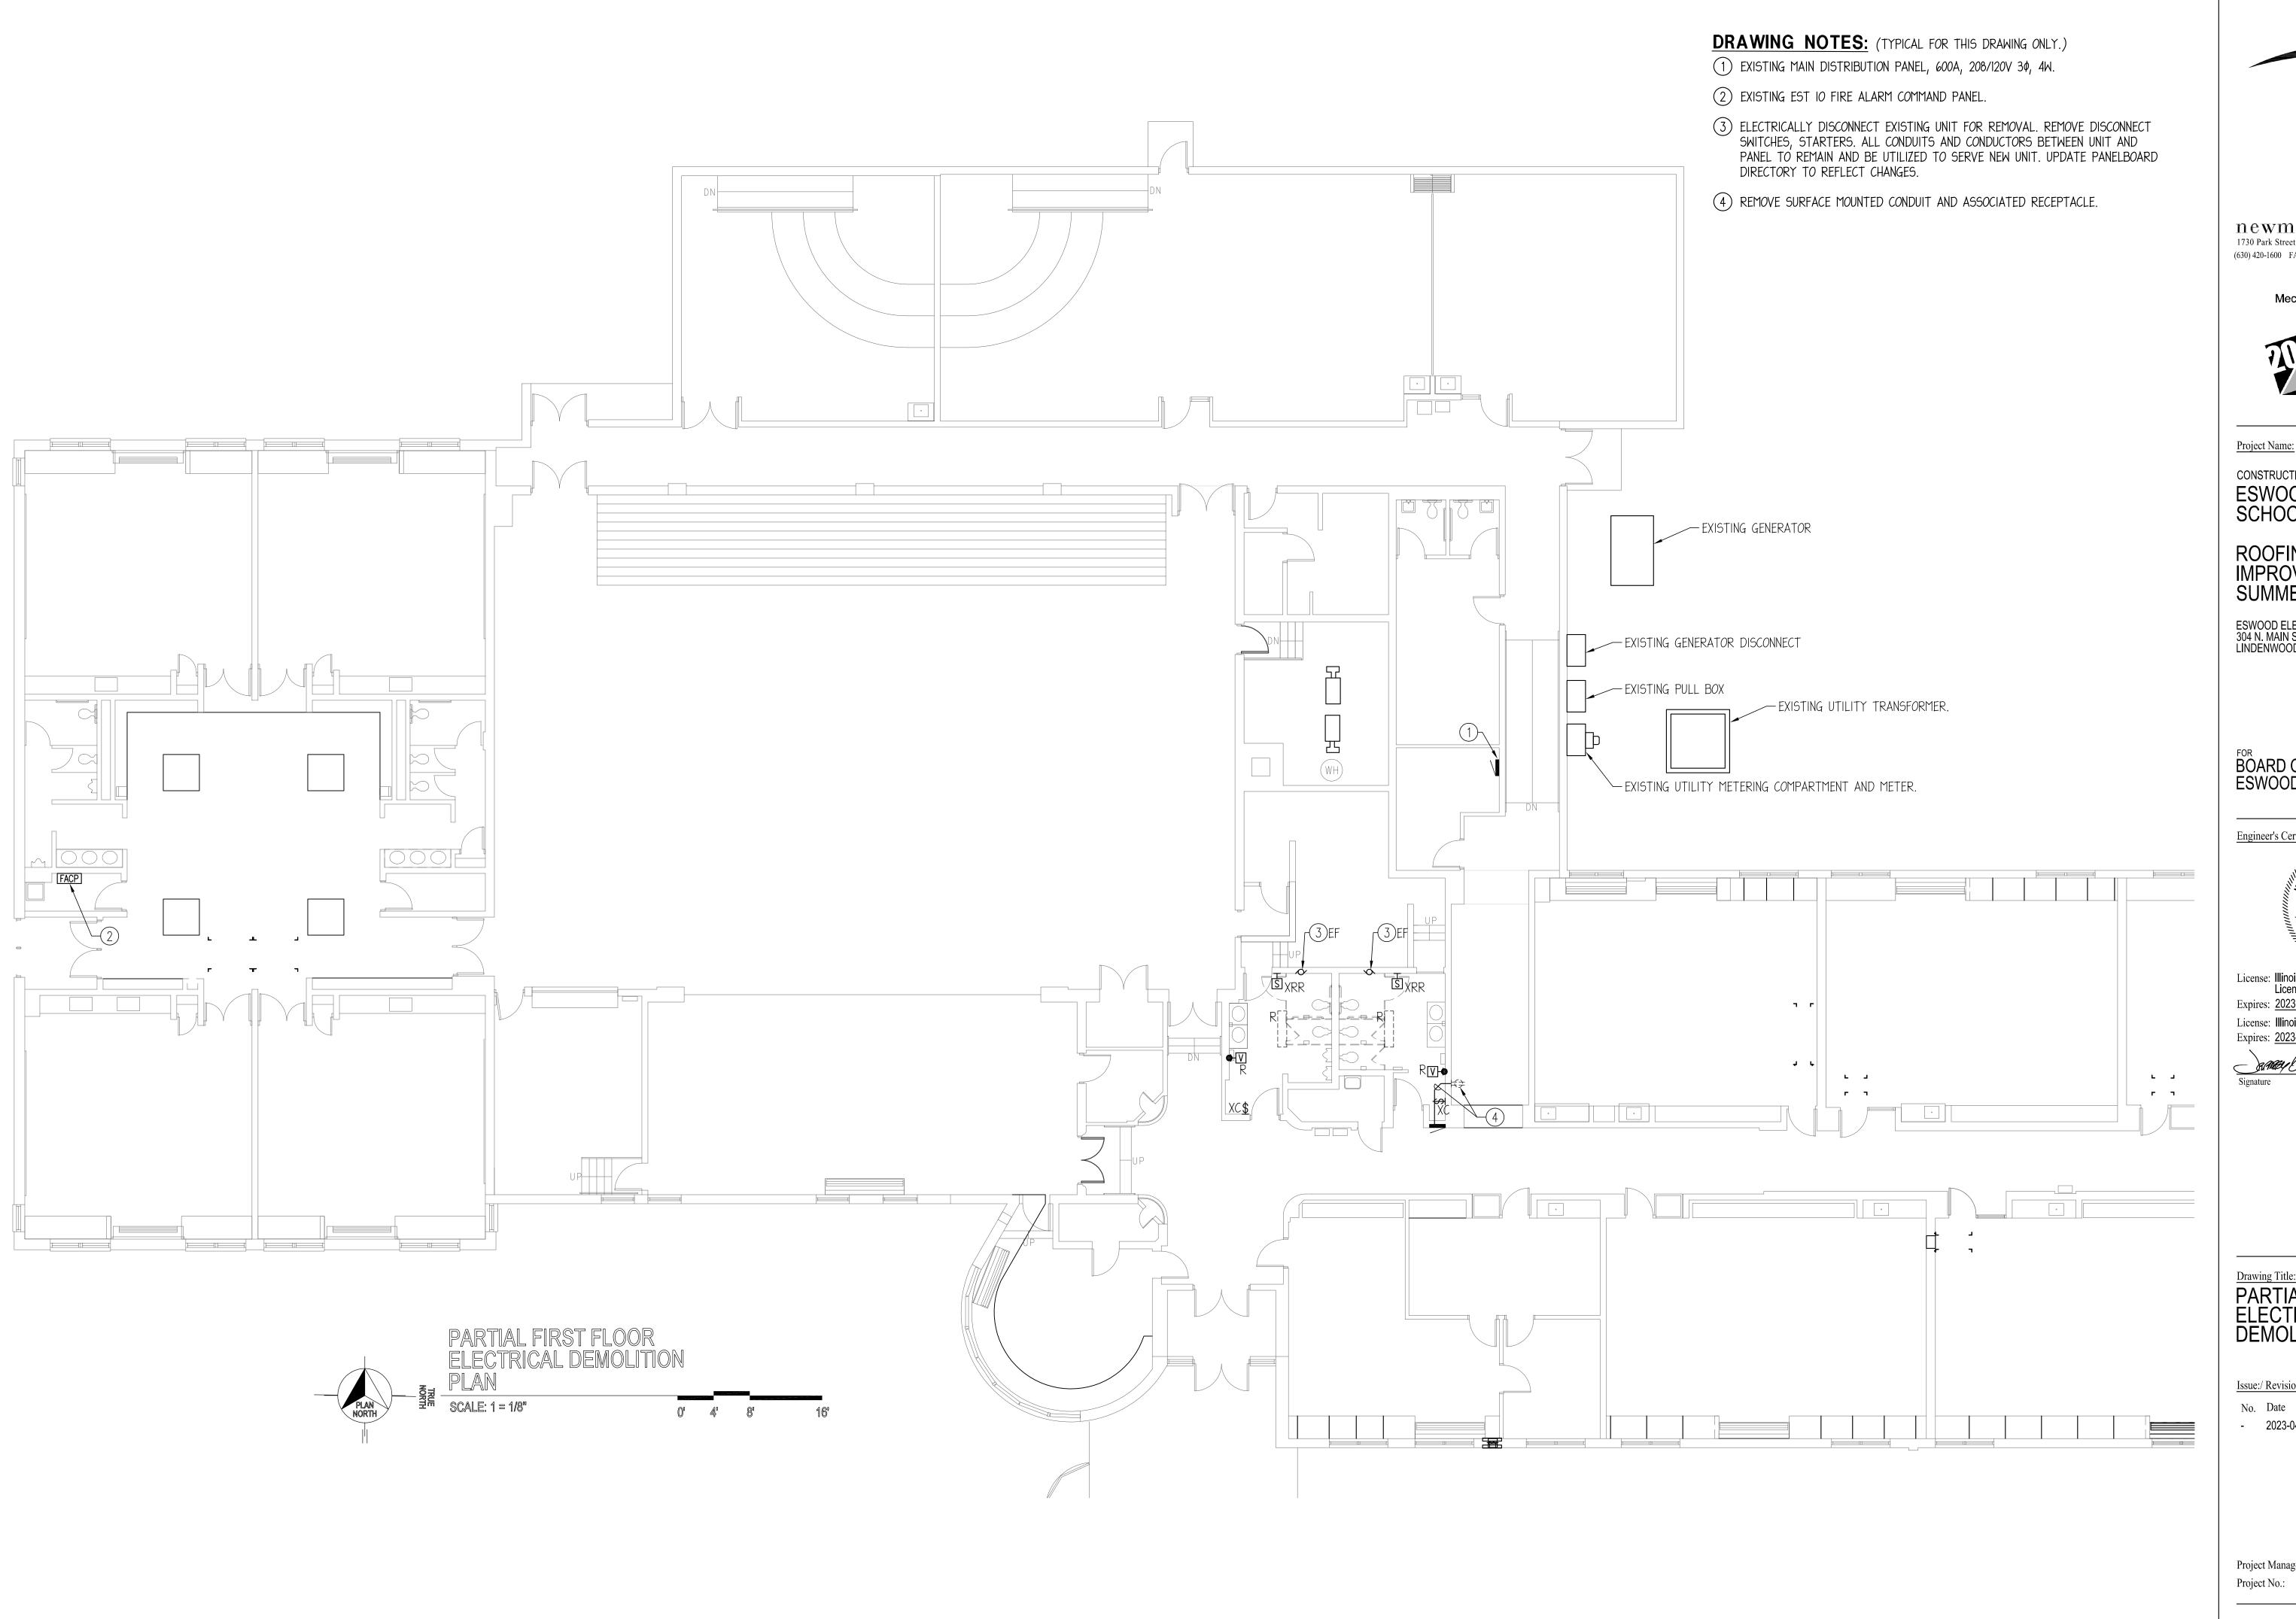

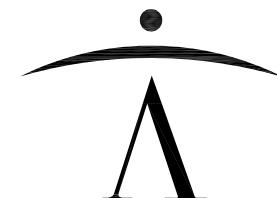

Mechanical - Electrical Engineers 1216 Tower Road Schaumburg, Illinois 60173 847.882.2010 Fax 847.882.2201

Project Name:

CONSTRUCTION DOCUMENTS **ESWOOD** SCHOOL

ROOFING IMPROVEMENTS -SUMMER 2023

ESWOOD ELEMENTARY SCHOOL 304 N. MAIN STREET LINDENWOOD, ILLINOIS 61049

BOARD OF EDUCATION ESWOOD CCSD 269

Engineer's Certification: 40860

REGISTERED
PROFESSIONAL
ENGINEER
OF KLINO'S

License: Illinois Professional Design Firm License No. 184-004110
Expires: 2023-04-30

License: Illinois Registration No. 062-040860
Expires: 2023-11-30

Signature $\frac{2023-04-18}{\text{Date}}$


Drawing Title:
PARTIAL FIRST FLOOR
ELECTRICAL
DEMOLITION PLAN

Issue:/ Revision:

Description - 2023-04-18 ISSUED FOR BID

Project Manager: CRN


Project No.: 2022052 Date: 2023-04-18

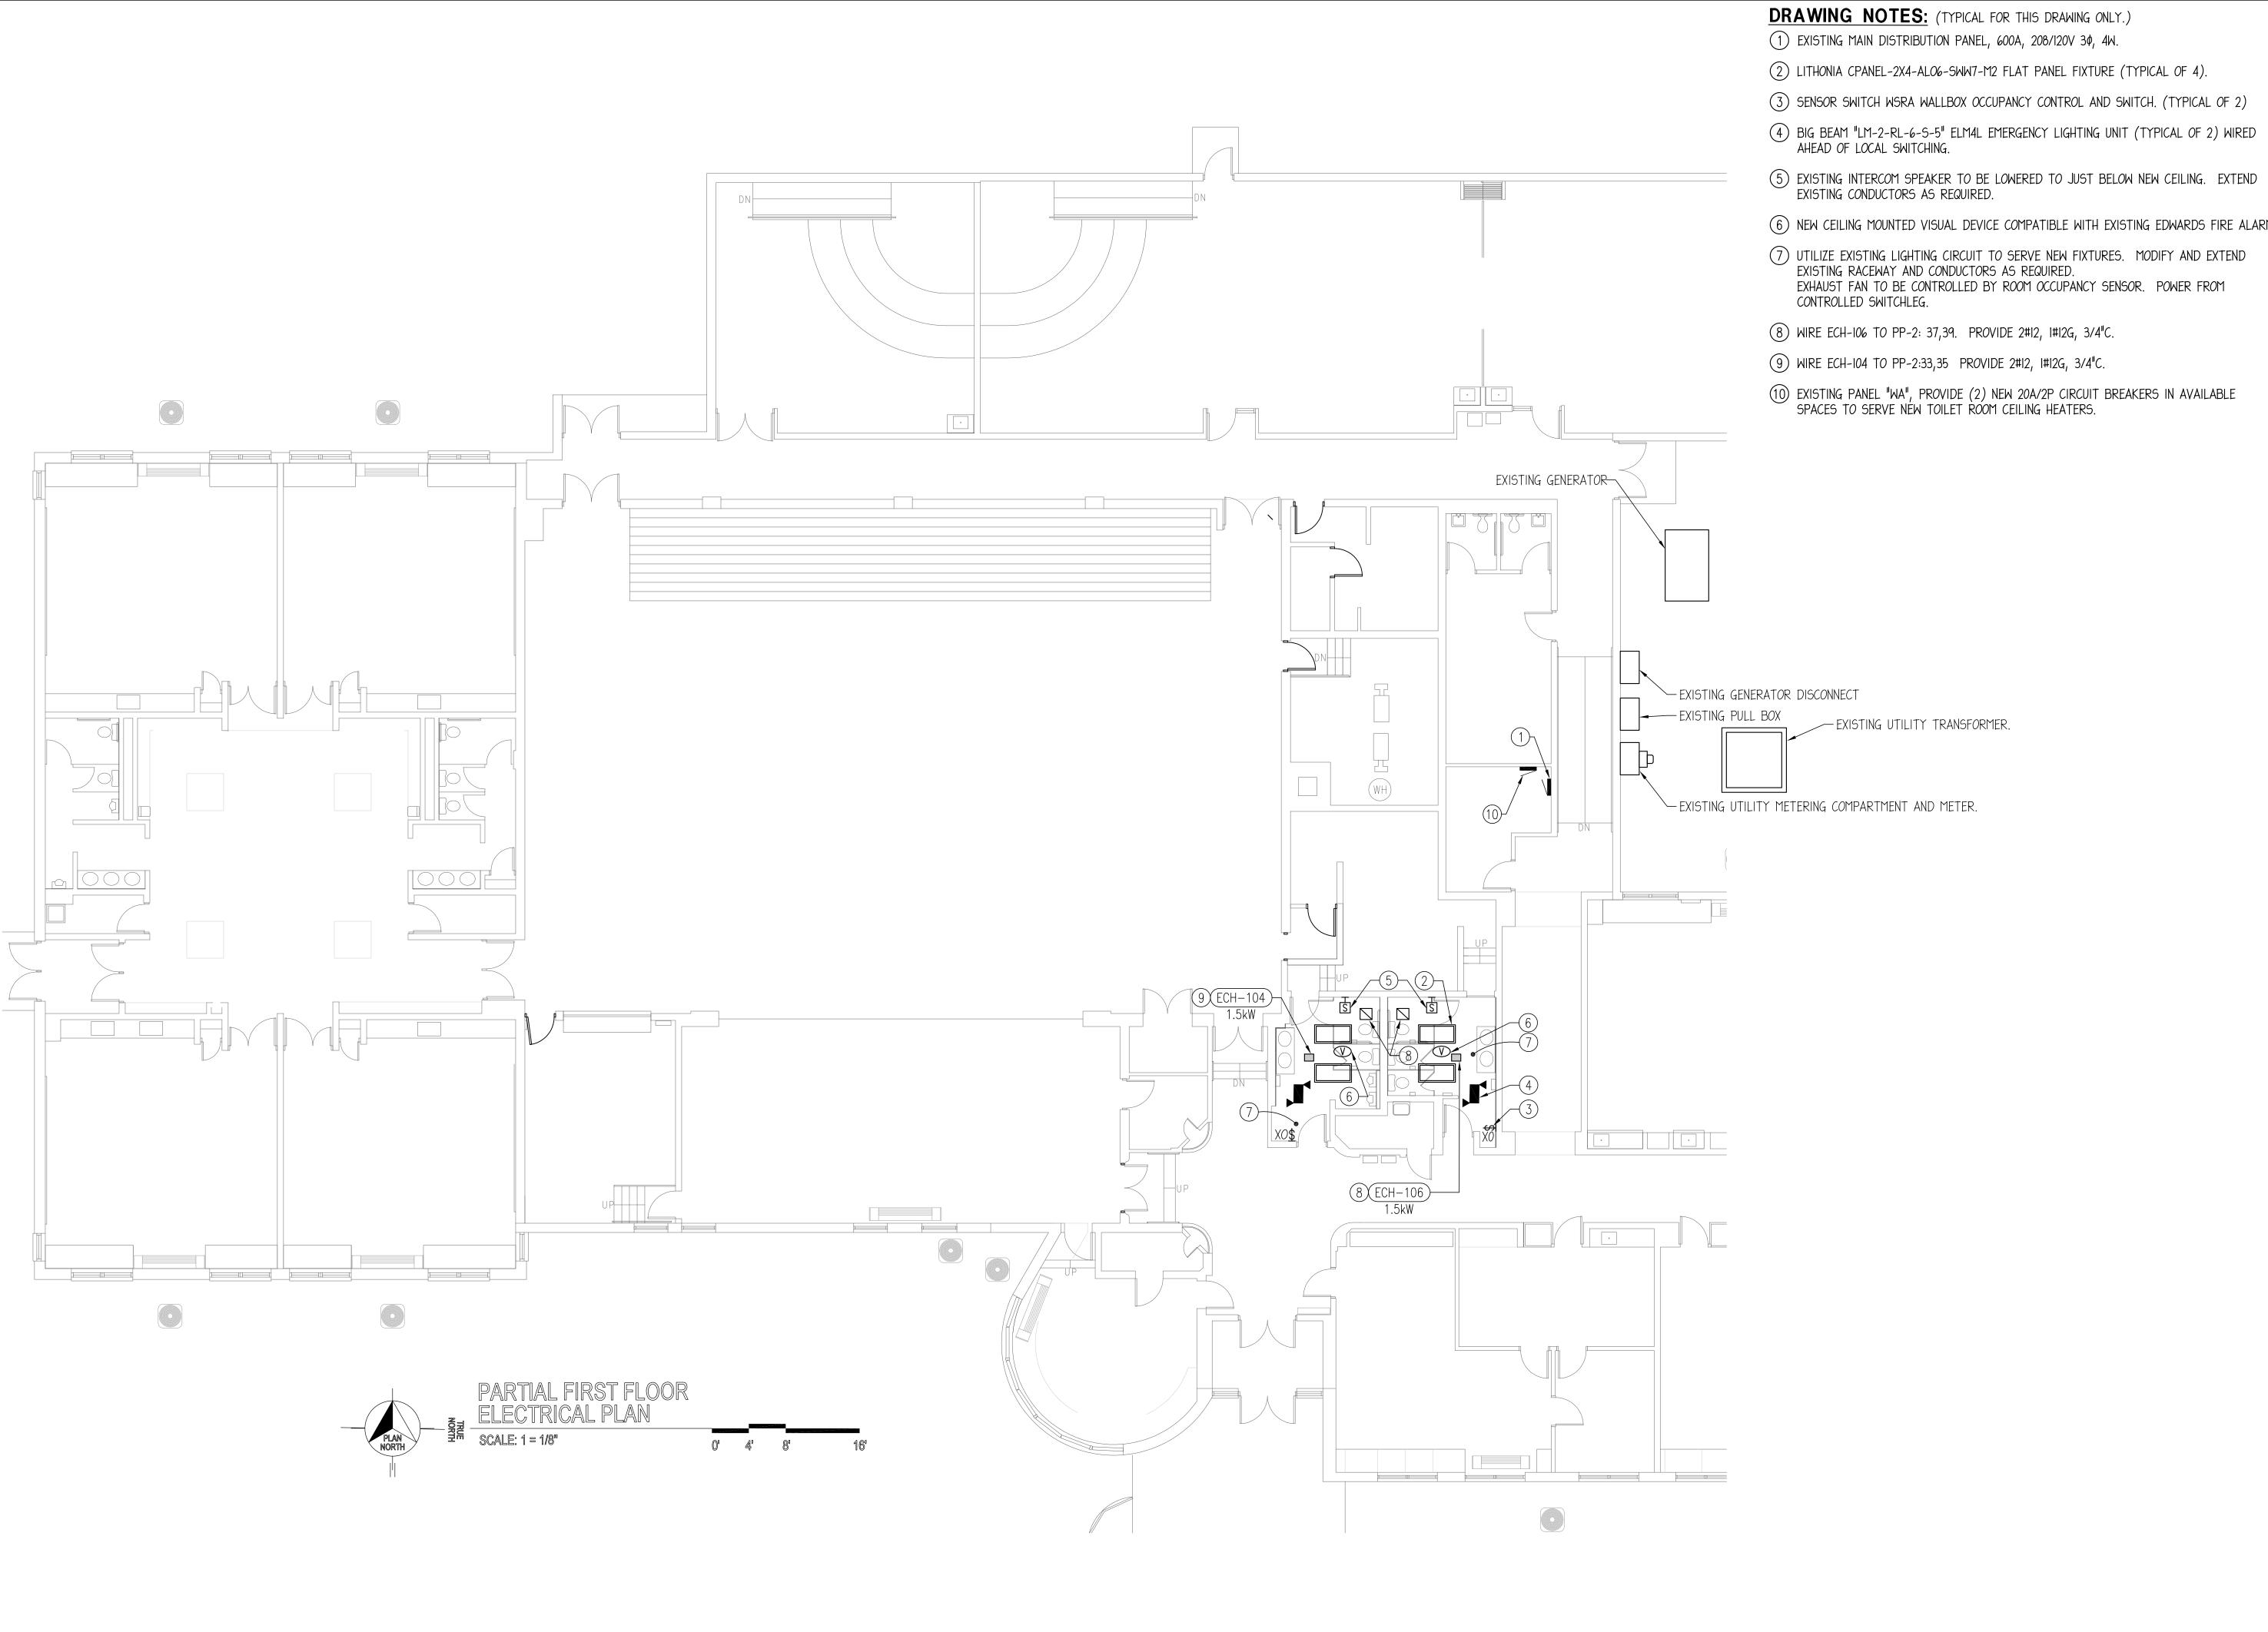



- 2 LITHONIA CPANEL-2X4-ALO6-SWW7-M2 FLAT PANEL FIXTURE (TYPICAL OF 4).
- (3) SENSOR SWITCH WSRA WALLBOX OCCUPANCY CONTROL AND SWITCH. (TYPICAL OF 2)
- (5) EXISTING INTERCOM SPEAKER TO BE LOWERED TO JUST BELOW NEW CEILING. EXTEND EXISTING CONDUCTORS AS REQUIRED.
- 6 NEW CEILING MOUNTED VISUAL DEVICE COMPATIBLE WITH EXISTING EDWARDS FIRE ALARM.
- (7) UTILIZE EXISTING LIGHTING CIRCUIT TO SERVE NEW FIXTURES. MODIFY AND EXTEND EXHAUST FAN TO BE CONTROLLED BY ROOM OCCUPANCY SENSOR. POWER FROM

- (10) EXISTING PANEL "WA", PROVIDE (2) NEW 20A/2P CIRCUIT BREAKERS IN AVAILABLE SPACES TO SERVE NEW TOILET ROOM CEILING HEATERS.

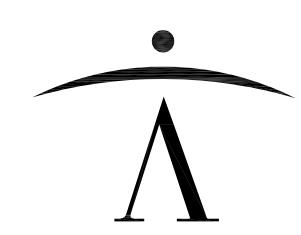

Mechanical - Electrical Engineers 1216 Tower Road Schaumburg, Illinois 60173 847.882.2010 Fax 847.882.2201

Project Name:


CONSTRUCTION DOCUMENTS **ESWOOD** SCHOOL

ROOFING IMPROVEMENTS -SUMMER 2023

ESWOOD ELEMENTARY SCHOOL 304 N. MAIN STREET LINDENWOOD, ILLINOIS 61049

BOARD OF EDUCATION ESWOOD CCSD 269

Engineer's Certification:

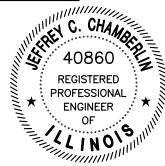

License: Illinois Professional Design Firm License No. 184-004110
Expires: 2023-04-30

License: Illinois Registration No. 062-040860 Expires: 2023-11-30

2023-04-18


Drawing Title:
PARTIAL FIRST FLOOR
ELECTRICAL PLAN

Issue:/ Revision:

No. Date - 2023-04-18 ISSUED FOR BID


Project Manager: CRN

Project No.: 2022052 Date: 2023-04-18

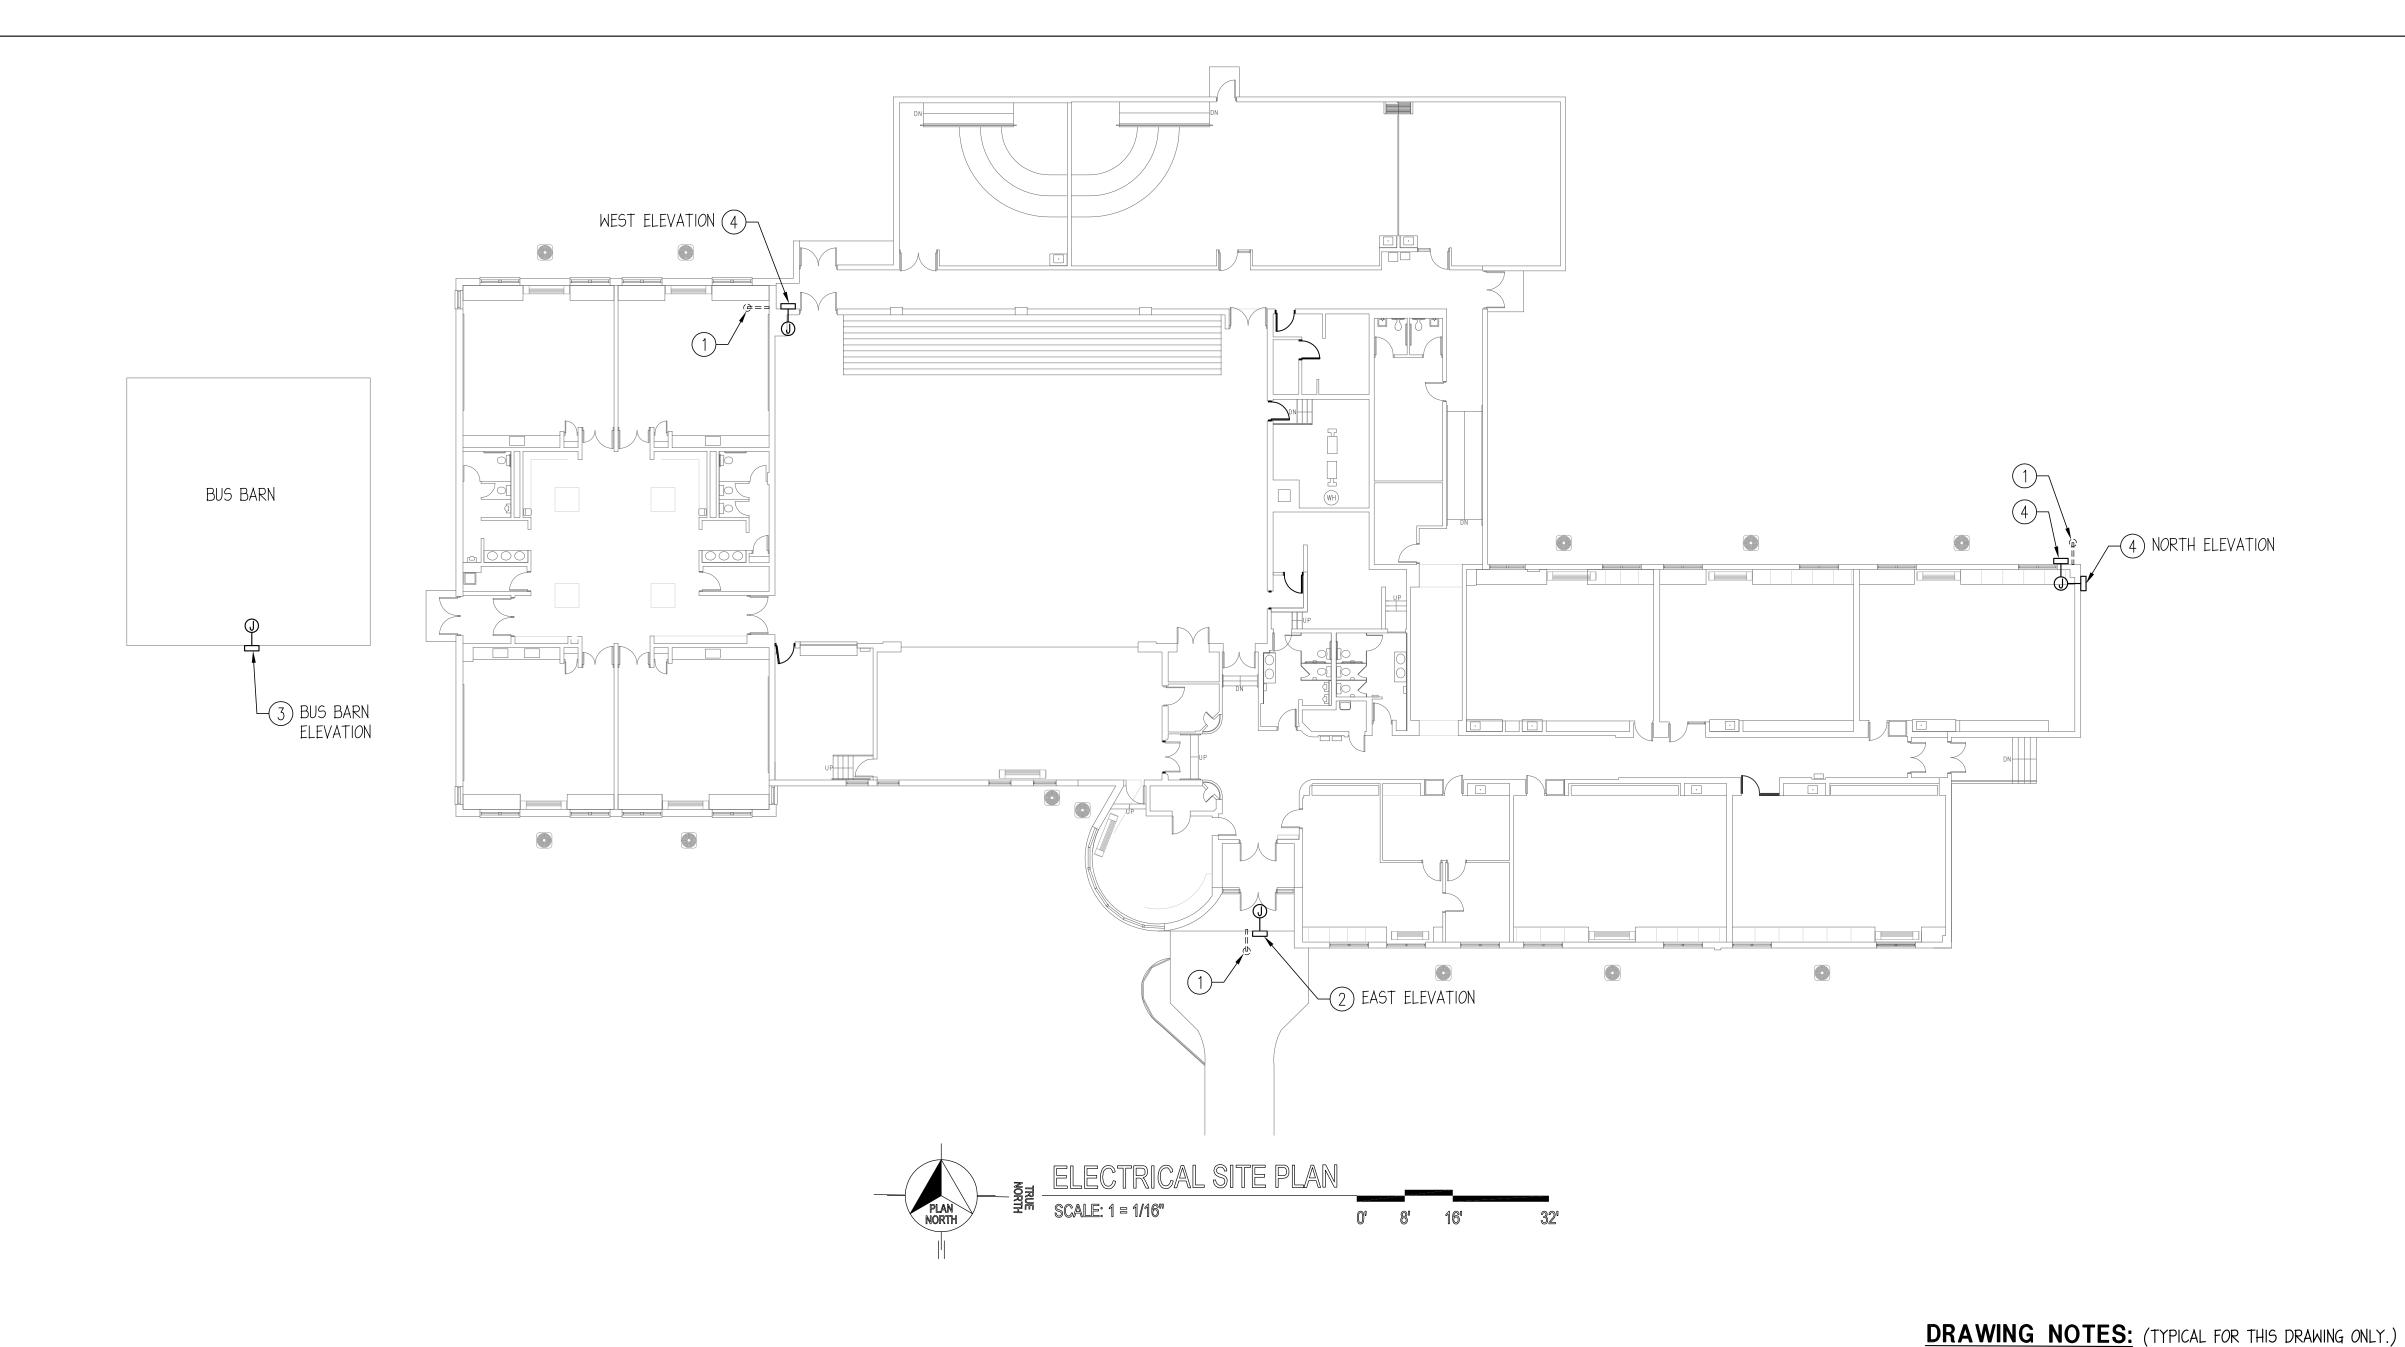



NORTH ELEVATION SCALE: NTS

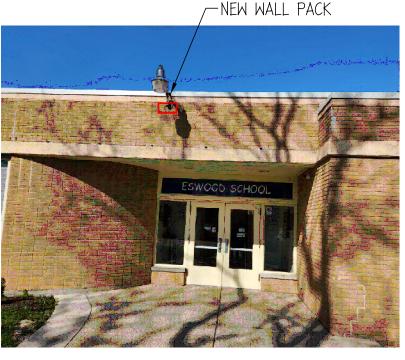

EAST ELEVATION SCALE: NTS



WEST ELEVATION SCALE: NTS



BUS BARN ELEVATION SCALE: NTS



newman architecture 1730 Park Street, Suite 115, Naperville, Illinois 60563-2611 (630) 420-1600 FAX (630) 420-1987 www.newmanarchitecture.com

Mechanical - Electrical Engineers 1216 Tower Road Schaumburg, Illinois 60173 847.882.2010 Fax 847.882.2201

Project Name:

CONSTRUCTION DOCUMENTS **ESWOOD** SCHOOL

ROOFING **IMPROVEMENTS** -SUMMER 2023

ESWOOD ELEMENTARY SCHOOL 304 N. MAIN STREET LINDENWOOD, ILLINOIS 61049

BOARD OF EDUCATION ESWOOD CCSD 269

Engineer's Certification:

1) DEMOLISH EXISTING MAST MOUNTED AREA LIGHT FIXTURE, REMOVED EXPOSED WIRING BACK TO FIRST ACCESSIBLE JUNCTION BOX.

(2) PROVIDE NEW WALL PACK (LITHONIA WST-P2-40K-VW-MVOLT-PBBW-PE) WITH FACTORY

NEW FIXTURE. CONDUIT SHALL ENTER SURFACE BACK BOX FROM BACK OF FIXTURE.

RACEWAY AND CONDUCTORS SHALL BE 1/2"C MINIMUM WITH #12 CONDUCTORS.

SHALL BE 1/2"C MINIMUM WITH #12 CONDUCTORS.

(3) PROVIDE FLOOD LIGHT (LITHONIA RSXFI-LED-P2-40K-AWFD-MVOLT-AAWSC-PE) WITH FACTORY PROVIDED SURFACE MOUNT BACK BOX. INTERCEPT EXISTING UNSWITCHED

(4) PROVIDE FLOOD LIGHT (LITHONIA RSXFI-LED-P2-40K-AWFD-MVOLT-AAWSC-PE) WITH

NEARBY DEMOLISHED FIXTURE WITHIN THE BUILDING AND EXTEND RACEWAY AND

PROVIDED SURFACE MOUNT BACK BOX. INTERCEPT EXISTING CIRCUIT SERVING NEARBY

DEMOLISHED FIXTURE WITHIN THE BUILDING AND EXTEND RACEWAY AND CONDUCTORS TO

RECEPTACLE CIRCUIT WITHIN BUS BARN AND EXTEND TO SERVE NEW WALL PACK. CONDUIT SHALL ENTER SURFACE BACK BOX FROM BACK OF FIXTURE. RACEWAY AND CONDUCTORS

FACTORY PROVIDED SURFACE MOUNT BACK BOX. INTERCEPT EXISTING CIRCUIT SERVING

CONDUCTORS TO NEW FIXTURE. CONDUIT SHALL ENTER SURFACE BACK BOX FROM BACK

OF FIXTURE. RACEWAY AND CONDUCTORS SHALL BE 1/2"C MINIMUM WITH #12 CONDUCTORS.



License: Illinois Professional Design Firm License No. 184-004110

Expires: <u>2023-04-30</u> License: Illinois Registration No. 062-040860 Expires: <u>2023-11-30</u>

Drawing Title: ELECTRICAL SITE PLAN

Issue:/ Revision:


No. Date Description - 2023-04-18 ISSUED FOR BID

Project Manager: CRN Project No.: 2022052 Date: 2023-04-18

E2-2



OWER	SYMBOL LIST	ELEC	TRICAL ABBREVIATIONS
(WP,WR) (GFI)	20A. 2P, 3 WIRE, GROUNDING TYPE, 125V. SPECIFICATION-GRADE, TAMPER RESISTANT DUPLEX	Α	AMPERES
± (GFI) ∯	RECEPTACLE NEMA 5-20R INSTALLED 16" A.F.F. U.N.O. - "GFI" DENOTES RECEPTACLE EQUIPPED WITH INTEGRAL GROUND FAULT CIRCUIT INTERRUPTER. - "WP" DENOTES WEATHER RESISTANT RECEPTACLE WITH WHILE-IN-USE WEATHERPROOF COVER.	AFCI	ARC FAULT CIRCUIT INTERRUPTER
, ,	- "WR" DENOTES WEATHER RESISTANT RECEPTACLE.	A.F.F.	ABOVE FINISHED FLOOR
₩P,WR) ∰(GFI)	20A. 2P, 3 WIRE, GROUNDING TYPE, 125V. SPECIFICATION-GRADE, TAMPER RESISTANT, DUPLEX RECEPTACLE NEMA 5-20R INSTALLED 6" ABOVE COUNTER TOP OR 42" A.F.F. U.N.O.	С	CONDUIT
\$	- "GFI" DENOTES RECEPTACLE EQUIPPED WITH INTEGRAL GROUND FAULT CIRCUIT INTERRUPTER "WP" DENOTES WEATHER RESISTANT RECEPTACLE WITH WHILE-IN-USE WEATHERPROOF COVER.	C/B	CIRCUIT BREAKER
	- "WR" DENOTES WEATHER RESISTANT RECEPTACLE.	CT	CURRENT TRANSFORMER
∰ (WP,WR) ∰ (GFI)	TWO 20A. 2P, 3 WIRE, GROUNDING TYPE, SPECIFICATION-GRADE, TAMPER RESISTANT, DUPLEX RECEPTACLES NEMA 5-20R INSTALLED 16" A.F.F. U.N.O.	CU	COPPER
\$	- "GFI" DENOTES RECEPTACLE EQUIPPED WITH INTEGRAL GROUND FAULT CIRCUIT INTERRUPTER "WP" DENOTES WEATHER RESISTANT RECEPTACLE WITH WHILE-IN-USE WEATHERPROOF COVER.	EC	ELECTRICAL CONTRACTOR
	- "WR" DENOTES WEATHER RESISTANT RECEPTACLE.	EM	EMERGENCY
(1)	CEILING JUNCTION BOX.	FLA	FULL LOAD AMPS
Φ	WALL MOUNTED JUNCTION BOX.	G, GRD.	GROUND
D L.	JUNCTION BOX WITH FLEXIBLE CONDUIT FOR FINAL CONNECTION TO EQUIPMENT.	GFI	GROUND FAULT CIRCUIT
	CIRCUIT BREAKER PANELBOARD.		INTERRUPTER
z –	ELECTRICAL DEVICE MOUNTED ON SURFACE RACEWAY, WIREMOLD V700 MINIMUM.	GFPE	GROUND FAULT PROTECTIVE EQUIPMENT
•	SURFACE MOUNTED (EXPOSED) CONDUIT, BACKBOX FOR DEVICE AS SHOWN.	HP	HORSEPOWER
#	CONDUIT ROUTED CONCEALED IN WALLS AND CEILING. HASH MARKS DENOTE QUANTITY OF #12 MINIMUM AWG CONDUCTORS OR AS NOTED.	I.T.	INFORMATION TECHNOLOGY
	CONDUIT ROUTED EXPOSED. INSTALL PARALLEL TO WALLS AND CEILINGS. HASH MARKS DENOTE	KCM	THOUSAND CIRCULAR MILS
1	QUANTITY OF #12 MINIMUM AWG CONDUCTORS OR AS NOTED.	MAX	MAXIMUM
	CONDUIT ROUTED BELOW GRADE. HASH MARK DENOTES QUANTITY OF $\#12$ MINIMUM AWG CONDUCTORS OR AS NOTED.	MCA	MINIMUM CIRCUIT AMPS
1100	-DENOTES CONDUIT HOMERUN, 3/4" MINIMUM, PANEL DESTINATION AND CIRCUIT NUMBER(S) AS INDICATED.		
	-SHORT TICK MARK DENOTES LINE (HOT) OR SWITCH LEG CONDUCTOR, #12 MINIMUM AWG.		FLEXIBLE CONNECT
	-LONG TICK MARK DENOTES NEUTRAL CONDUCTOR, #10 AWG MINIMUM.		LIGHT FIXTURE
\	-DENOTES INSULATED GROUND WIRE, #12 AWG MINIMUM.	ı	

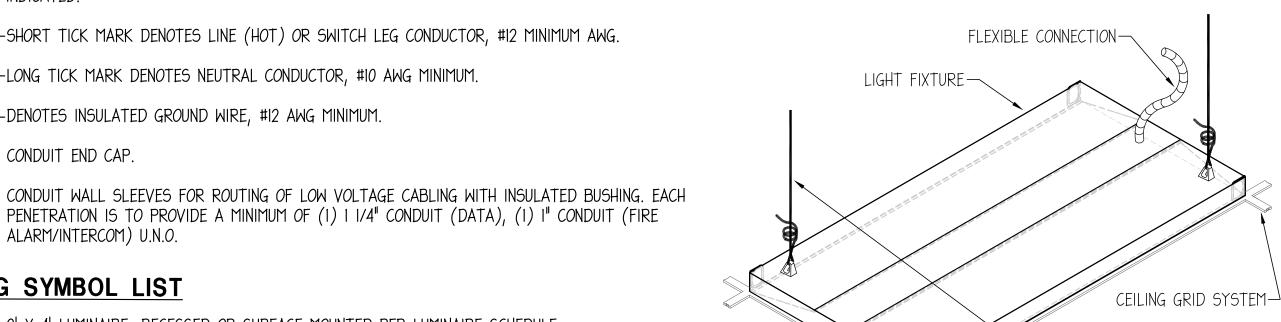

LIGHT FIXTURE SUPPORT DETAIL

NO SCALE

LIGHTING SYMBOL LIST

CONDUIT END CAP.

ALARM/INTERCOM) U.N.O.

2' X 4' LUMINAIRE, RECESSED OR SURFACE MOUNTED PER LUMINAIRE SCHEDULE

2' X 4' PARABOLIC LUMINAIRE, RECESSED OR SURFACE MOUNTED PER LUMINAIRE SCHEDULE

PENETRATION IS TO PROVIDE A MINIMUM OF (I) I 1/4" CONDUIT (DATA), (I) I" CONDUIT (FIRE

I' X 4' LUMINAIRE, RECESSED OR SURFACE MOUNTED PER LUMINAIRE SCHEDULE.

2' X 2' LUMINAIRE, RECESSED OR SURFACE MOUNTED PER LUMINAIRE SCHEDULE.



 \rightarrow

 $\overline{\Box}$

HALF SHADING DENOTES FIXTURE UNSWITCHED "NIGHTLIGHT"

SELF-CONTAINED EMERGENCY LUMINAIRE, WITH BATTERY BACK-UP AND SOLID STATE CHARGER PER SCHEDULE.

- "WG" DENOTES WIRE GUARD.

WALL MOUNT COMBINATION OCCUPANCY SENSOR AND SWITCH AS SCHEDULED INSTALLED 48" A.F.F. TO TOP OF DEVICE.

FIRE ALARM SYMBOL LIST

FIRE ALARM SYSTEM VISUAL NOTIFICATION INSTALLED 80" A.F.F.

- "WG" DENOTES WIRE GUARD.

FIRE ALARM SYSTEM CEILING VISUAL NOTIFICATION.

- "WG" DENOTES WIRE GUARD.

FIRE ALARM CONTROL PANEL.

DATA AND COMMUNICATIONS SYMBOL LIST

S (VR,WP) WALL MOUNTED SPEAKER.

- "VR" DENOTES VANDAL RESISTANT HOUSING.

- "WP" DENOTES WEATHERPROOF ENCLOSURE. INSTALL RECESSED BACK BOX.

DEMOLITION PLAN GENERAL NOTES

MAIN CIRCUIT BREAKER

MAXIMUM OVERCURRENT

POTENTIAL TRANSFORMER

SURGE PROTECTIVE DEVICE

UNLESS NOTED OTHERWISE

MINIMUM

MAIN LUGS ONLY

PROTECTION

TAMPER PROOF

VOLT - AMPERES

WIRE GUARD

WEATHER PROOF

TRANSFORMER

SINGLE POLE

TWO POLE

THREE POLE

PHASE

STEEL CABLE SUPPORTS AT

OPPOSITE CORNERS OF FIXTURE.

TIE TO STRUCTURAL MEMBER.

TYPICAL

VOLTS

MIN

MOCP

TP

TYP.


- I. ALL INDICATED ELECTRICAL EQUIPMENT, FIXTURES, DEVICES, AND RELATED CONDUIT AND WIRING TO BE REMOVED UNLESS NOTED OTHERWISE
- 2. ALL DEMOLITION OF THE ELECTRICAL SYSTEM AS NOTED ON THE DEMOLITION DRAWINGS SHALL BE COORDINATED WITH THE RENOVATION REQUIREMENTS TO DETERMINE THIS CONTRACTOR'S WORK.
- 3. IT IS THE INTENT OF THE ELECTRICAL DEMOLITION DRAWING(S) TO INDICATE AREAS IN WHICH ELECTRICAL EQUIPMENT, CONDUIT, LUMINAIRES, DEVICES, ETC. NEED TO BE REMOVED, RELOCATED, OR MODIFIED BY THIS CONTRACTOR TO ALLOW FOR THE RENOVATION PHASE OF CONSTRUCTION. THE ELECTRICAL DEMOLITION PLAN IS FOR REFERENCE PURPOSES ONLY AND IT IS NOT INTENDED TO BE THE SOLE SOURCE OF EXISTING CONDITIONS.
- 4. CONTRACTOR SHALL VISIT THE BUILDING, BEFORE SUBMITTING THEIR BID, TO VERIFY THE EXISTING CONDITIONS WHICH WILL AFFECT THEIR WORK.
- 5. CONTRACTOR SHALL BE RESPONSIBLE FOR THE COMPLETE ELECTRICAL DEMOLITION REQUIRED TO ACCOMMODATE THE RENOVATION. REMOVE AS REQUIRED ALL LUMINAIRES, CONNECTIONS TO MECHANICAL EQUIPMENT, DEVICES, ETC.. PULL OUT ALL UNUSED CONDUCTORS AND CABLES, AND REMOVE ALL ABANDONED CONDUIT. ELECTRICALLY DISCONNECT AIR HANDLING UNITS, PUMPS, BOILERS, AND OTHER SUCH EQUIPMENT FOR REMOVAL BY OTHERS. BACKFEED AS REQUIRED ALL DOWNSTREAM DEVICES WHICH REMAIN. (THE CONTRACTOR SHALL COORDINATE WITH THE OWNER WHICH ITEMS INDICATED TO BE REMOVED & DISCONNECTED SHALL BE SALVAGED AND PRESENTED TO THE OWNER PRIOR TO ANY DISPOSAL OF THESE
- 6. ALL REMOVED EQUIPMENT SHALL BECOME THE PROPERTY OF THE CONTRACTOR AND SHALL BE REMOVED FROM THE SITE. WHERE WORK CALLED FOR ON THE DRAWINGS OR IN THE SPECIFICATIONS INVOLVES THE REMOVAL OF FLUORESCENT LAMPS CONTAINING MERCURY OR CLOTH INSULATED CONDUCTORS, THEY SHALL BE PROPERLY HANDLED AND REMOVED FROM SITE BY APPROVED METHODS PER EPA REGULATIONS.
- 7. ALL EXISTING RECEPTACLES/DATA OUTLETS/DEVICES/EQUIPMENT THAT ARE NOT PART OF DEMOLITION SHALL REMAIN AS IS UNLESS NOTED OTHERWISE, CONTRACTOR SHALL CHECK AND VERIFY FOR CONTINUING OPERATION OF THESE DEVICES PRIOR TO SUBSTANTIAL COMPLETION. IF ANY EXISTING CIRCUITS TO REMAIN ARE INTERRUPTED BY DEMOLITION OR NEW CONSTRUCTION, CONTRACTOR SHALL BE RESPONSIBLE FOR REPLACEMENT/REMOVAL/REROUTING/MODIFICATION OF CONDUITS AND WIRES INCLUDING EXTENSION, AS REQUIRED TO MAINTAIN FUNCTIONALITY OF DOWNSTREAM RECEPTACLES/DATA OUTLETS/DEVICES/EQUIPMENT.
- 8. THE CONTRACTOR SHALL COORDINATE WITH THE PROJECT PHASING AND MAINTAIN EXISTING SYSTEMS ACTIVE IN AREAS WHICH REMAIN OCCUPIED.
- 9. EXISTING CEILING MOUNTED SPEAKERS, PROGRAM BELLS, FIRE ALARM DEVICES, AND SIMILAR ELECTRICAL EQUIPMENT AND DEVICES TO REMAIN SHALL BE EXTENDED AND REINSTALLED AS REQUIRED IN NEW CEILINGS. FIELD VERIFY EXACT QUANTITIES AND REQUIREMENTS.
- 10. SUPPORT ALL CABLING DRAPED OR LYING LOOSE ABOVE EXISTING CEILINGS WHICH ARE SCHEDULED TO BE REMOVED. TIE WRAP CABLING TO JOISTS OR OTHER STRUCTURAL MEMBERS AS REQUIRED. UPON THE COMPLETION OF THE PROJECT, NO WIRING SHALL BE LYING ON ACCESSIBLE CEILINGS.
- II. WHERE EXISTING DEVICE IS REMOVED FROM WALL WITH NO NEW DEVICE GOING BACK AT SAME LOCATION, PROVIDE BLANK COVER PLATES AS REQUIRED. COVER PLATES SHALL BE OF PROPER SIZE AND INSTALLED FLUSH WITH WALL.

LIGHTING PLAN GENERAL NOTES

- 1. THE MINIMUM WIRE SIZE SHALL BE #12 AWG EXCEPT FOR SHARED NEUTRAL CONDUCTORS WHICH THE MINIMUM SIZE SHALL BE #10 AWG. THE MINIMUM CONDUIT SIZE FOR HOMERUNS SHALL BE 3/4". 1/2" CONDUIT IS ACCEPTABLE FOR BRANCH WIRING TO LUMINAIRES WHERE APPLICABLE. ALL LIGHTING BRANCH CIRCUITS SHALL TERMINATE AT 20A/I-POLE CIRCUIT BREAKERS IN PANELBOARD INDICATED UNLESS NOTED OTHERWISE.
- 2. PROVIDE LOCK-ON CIRCUIT BREAKER DEVICES FOR ALL EMERGENCY LIGHTING & EXIT SIGN BRANCH CIRCUITS.
- 3. REFER TO ARCHITECTURAL REFLECTED CEILING PLANS FOR EXACT LUMINAIRE LOCATIONS. REFER TO ARCHITECTURAL ELEVATIONS FOR LUMINAIRE SUSPENSION LENGTHS AND MOUNTING HEIGHTS.
- 4. ALL LUMINAIRES SHOWN HALF SHADED SHALL BE WIRED (NON-SWITCHED CIRCUIT) DIRECTLY TO THE EMERGENCY PANEL. PROVIDE DEDICATED NEUTRAL CONDUCTOR TO EACH BRANCH CIRCUIT TO THE EMERGENCY PANEL.
- 5. CIRCUIT NUMBER(S), WHERE SHOWN, ARE TO INDICATE QUANTITY OF CIRCUITS REQUIRED. VERIFY EXACT CIRCUIT NUMBER TO BE UTILIZED IN FIELD. CONTRACTOR SHALL PROVIDE ACTUAL CIRCUITING AS PART OF "AS BUILT" DRAWINGS.
- 6. EMERGENCY BATTERY PACKS SHOWN ARE TO BE CONNECTED TO THE NEAREST LIGHTING BRANCH CIRCUIT AHEAD OF LOCAL SWITCH UNLESS NOTED OTHERWISE.
- 7. ALL LAY-IN FIXTURES SHALL BE INDEPENDENTLY SUPPORTED AT OPPOSITE CORNERS TO A STRUCTURAL MEMBER.
- 8. PROVIDE PULL BOX(ES) BETWEEN PULL POINTS AS REQUIRED TO COMPLY WITH NEC 344.26 SUCH THAT THERE SHALL NOT BE MORE THAN THE EQUIVALENT OF FOUR QUARTER BENDS (360 DEGREE TOTAL) BETWEEN PULL POINTS.
- 9. ALL DIMMING SYSTEM CONTROL WIRING SHALL BE RATED AT 600V AND SHALL BE IN THE SAME CONDUIT AS THE CIRCUIT PROVIDING POWER TO THE LIGHT FIXTURE. CONDUIT SHALL BE 1/2" MINIMUM FOR DIMMING SYSTEM CONTROL WIRING WHERE RAN INDEPENDENT OF THE CIRCUIT SUPPLYING POWER TO THE FIXTURES.
- 10. PROVIDE SEPARATE NEUTRAL FOR ALL DIMMED CIRCUITS.
- II. IN NEW WORK, CONTRACTOR SHALL PROVIDE COMMON DISCONNECTING MEANS FOR BRANCH CIRCUITS UTILIZING SHARED NEUTRALS PER ARTICLE 210.4(B). HANDLE TIES ARE ACCEPTABLE WHEN BREAKERS ARE "SLASH RATED" FOR THE HIGHER SYSTEM VOLTAGE RATING OF THE SYSTEM. WHEN HANDLE TIES ARE NOT POSSIBLE DUE TO NON-ADJACENT BREAKERS, PROVIDE A DEDICATED NEUTRAL FOR EACH UNGROUNDED CONDUCTOR.
- 12. IN EXISTING WORK WHEN UTILIZING EXISTING SPACES OR SPARES, CONTRACTOR SHALL PROVIDE DEDICATED NEUTRAL FOR EACH BRANCH CIRCUIT UNLESS HANDLE TIES ARE UTILIZED TO MEET THE REQUIREMENTS OF ARTICLE 210.4(B).
- 13. IN JUNCTION BOXES WHERE CURRENT CARRYING CONDUCTORS ARE SPLICED OR TERMINATED. PROVIDE BOND TO JUNCTION BOX FROM EQUIPMENT GROUNDING CONDUCTOR.

POWER PLAN GENERAL NOTES

- 1. THE MINIMUM WIRE SIZE SHALL BE #12 AWG EXCEPT FOR SHARED NEUTRAL CONDUCTORS WHICH THE MINIMUM SIZE SHALL BE #10 AWG. THE MINIMUM CONDUIT SIZE FOR HOMERUNS AND BRANCH FEEDS TO POWER OUTLETS SHALL BE 3/4". 1/2" CONDUIT IS ACCEPTABLE FOR BRANCH WIRING TO END OF THE LINE RECEPTACLES ONLY. ALL POWER BRANCH CIRCUITS SHALL TERMINATE AT 20A/I-POLE CIRCUIT BREAKERS IN PANELBOARD INDICATED UNLESS NOTED OTHERWISE.
- 2. THE CONTRACTOR SHALL PROVIDE ALL PENETRATIONS, SLEEVES, AND SEALANT AS REQUIRED THROUGH PARTITIONS TO ACCOMMODATE THE FIRE ALARM, PAGING, CLOCK, VOICE, AND DATA CABLING. ANY PENETRATIONS THROUGH WALLS AND FLOORS SHALL BE PROPERLY SEALED AND TREATED TO MAINTAIN THE FIRE STOPPING RATING OF THE WALLS, FLOORS, AND CEILINGS.
- 3. BACKBOXES ARE TO BE MOUNTED OFFSET, NOT BACK TO BACK.
- 4. CIRCUIT NUMBER(S), WHERE SHOWN, ARE TO INDICATE QUANTITY OF CIRCUITS REQUIRED VERIFY EXACT CIRCUIT NUMBER TO BE UTILIZED IN FIELD. CONTRACTOR SHALL PROVIDE ACTUAL CIRCUITING AS PART OF "AS BUILT" DRAWINGS.
- 5. UNLESS INDICATED OTHERWISE, ALL MATERIALS REQUIRED TO PROVIDE BRANCH CIRCUITS AND FEEDERS ARE TO BE NEW.
- 6. DURING THE COURSE OF INVESTIGATION AND DEMOLITION, IF IT IS DETERMINED THAT IT MAY BE FEASIBLE TO UTILIZE EXISTING MATERIALS FOR BRANCH CIRCUITS AND FEEDERS CONTRACTOR SHALL NOTIFY ENGINEER FOR APPROVAL PRIOR TO PERFORMING ANY WORK.
- 7. REFER TO MECHANICAL AND PLUMBING SHEETS FOR ADDITIONAL EQUIPMENT INFORMATION.
- 8. ANY ELECTRICAL DEVICES ON NEW AND EXISTING WALLS SHALL BE FLUSH MOUNTED. NO WIREMOLDS ARE ACCEPTABLE UNLESS NOTED OTHERWISE.
- 9. VERIFY RECEPTACLE LOCATIONS WITH ARCHITECTURAL FURNITURE LAYOUT TO ENSURE PROPER ACCESSIBILITY.
- 10. DRAWINGS DO NOT REPRESENT ALL EXISTING FIRE ALARM DEVICES. INITIATING AND NOTIFICATION DEVICES NOT SHOWN ON THE DRAWINGS ARE EXISTING TO REMAIN. IT IS THE CONTRACTOR'S RESPONSIBILITY TO MAINTAIN OPERATION OF THE EXISTING DEVICES NOT SHOWN.
- II. EXISTING FIRE ALARM SYSTEM SHALL BE OPERATIONAL AT ALL TIMES. THE OCCUPIED AREA OF THE BUILDING SHALL NOT BE LEFT UNPROTECTED AT ANY TIME. IF AN INTERRUPTION OF FIRE ALARM SYSTEM IS REQUIRED TO FACILITATE DEVICE INSTALLATION, PROVIDE 48 HOURS OF ADVANCE NOTICE TO THE OWNER AND THE LOCAL FIRE DEPARTMENT. CONTRACTOR SHALL HIRE AN AUTHORIZED PERSONNEL TO WATCH/GUARD ANY UNPROTECTED AREAS OF THE BUILDING WHERE NECESSARY.
- 12. UNLESS INDICATED ON ARCHITECTURAL DRAWINGS, THE CONTRACTOR SHALL BE RESPONSIBLE AND PAY FOR ALL CORING, CUTTING, PATCHING, REPAIRING, REFINISHING, AND REMOVAL/REPLACEMENT OF NEW OR EXISTING BUILDING CONSTRUCTION REQUIRED TO ACCOMMODATE THE INSTALLATION OR REMOVAL OF THEIR WORK, REMOVE, STORE, AND REINSTALL CEILING TILES AS REQUIRED TO INSTALL WORK ABOVE EXISTING REMOVABLE CEILINGS WHICH REMAIN; REPLACE TILES BROKEN OR DAMAGED DURING CONSTRUCTION. ALL PATCHING, REPAIRING, AND REFINISHING WORK TO OTHER FINISHES AND STRUCTURAL ELEMENTS SHALL BE PERFORMED BY THOSE REGULARLY INVOLVED IN THAT TRADE AND SHALL MATCH THE ADJACENT CONSTRUCTION AS CLOSELY AS POSSIBLE WHILE MAINTAINING EXISTING FIRE RATINGS. CONTRACTOR SHALL BE RESPONSIBLE FOR DETERMINING EXISTING FIRE RATINGS OF CEILINGS AND PARTITIONS SYSTEMS. CARE SHALL BE TAKEN SO AS NOT TO DAMAGE ANY EXISTING BUILDING CONSTRUCTION OR ITEMS THAT ARE TO REMAIN. ANY EXISTING FINISHES THAT ARE DAMAGED DURING THE INSTALLATION OF NEW WORK OR REMOVAL OF EXISTING WORK SHALL BE REPAIRED, REPLACED, AND PAID FOR BY THE INSTALLING CONTRACTOR TO THE SATISFACTION OF THE ARCHITECT AND OWNER. REFER TO ARCHITECTURAL DRAWINGS FOR EXISTING BUILDING CONSTRUCTION THAT IS TO REMAIN AND, THEREFORE, SUBJECT TO PATCHING, REPAIRING, REFINISHING, AND REMOVAL/REPLACEMENT.
- 13. REMOVE AND REINSTALL CEILING MOUNTED DEVICES AS REQUIRED TO ALLOW INSTALLATION OF FEEDERS, BRANCH CIRCUITS, MECHANICAL PIPING, AND DUCT WORK, DEVICES INCLUDE BUT ARE NOT LIMITED TO: LUMINAIRES, SPEAKERS, FIRE ALARM, AND PAGING DEVICES.
- 14. PROVIDE PULL BOX(ES) BETWEEN PULL POINTS AS REQUIRED TO COMPLY WITH NEC 344.26 SUCH THAT THERE SHALL NOT BE MORE THAN THE EQUIVALENT OF FOUR QUARTER BENDS (360) DEGREE TOTAL) BETWEEN PULL POINTS.
- 15. SPECIAL ATTENTION SHALL BE PAID TO ALL CONDUIT ROUTING IN OPEN CEILING SPACE FOR AESTHETIC PURPOSES, ALL EXPOSED CONDUITS SHALL BE ROUTED PERPENDICULAR AND PARALLEL TO BUILDING LINES AND TIGHT TO CEILING/STRUCTURAL CORNERS. WHERE IT IS NOT FEASIBLE TO CONCEAL RACEWAYS, SUBMIT CONDUIT ROUTING PLAN TO ARCHITECT/ENGINEER FOR APPROVAL PRIOR TO INSTALLATION.
- 16. IN RENOVATIONS, IF AN EXISTING RECEPTACLE/JUNCTION BOX LOCATION WILL END UP HIDDEN BEHIND PERMANENTLY INSTALLED EQUIPMENT OR CASEWORK, PROCEED AS NOTED BELOW: A. IF THE RECEPTACLE IS AN END OF LINE DEVICE (IT DOES NOT FEED OTHER DEVICES), IT SHALL BE REMOVED INCLUDING ASSOCIATED WIRING BACK TO LAST ACTIVE DEVICE OR
- JUNCTION BOX AND A BLANK COVER PLATE INSTALLED. B. IF THE RECEPTACLE DOES SERVE DOWNSTREAM DEVICES, REMOVE RECEPTACLE AND REWORK WIRING TO A NEW OR EXISTING JUNCTION BOX ABOVE CEILING SUCH THAT NO WIRES ARE PRESENT IN THE JUNCTION BOX. A BLANK COVER PLATE SHALL BE INSTALLED.
- 19. IN NEW WORK, CONTRACTOR SHALL PROVIDE COMMON DISCONNECTING MEANS FOR BRANCH CIRCUITS UTILIZING SHARED NEUTRALS PER ARTICLE 210.4(B). HANDLE TIES ARE ACCEPTABLE WHEN BREAKERS ARE "SLASH RATED" FOR THE HIGHER SYSTEM VOLTAGE RATING OF THE SYSTEM. WHEN HANDLE TIES ARE NOT POSSIBLE DUE TO NON-ADJACENT BREAKERS, PROVIDE A DEDICATED NEUTRAL FOR EACH UNGROUNDED CONDUCTOR.
- 20. IN EXISTING WORK WHEN UTILIZING EXISTING SPACES OR SPARES, CONTRACTOR SHALL PROVIDE DEDICATED NEUTRAL FOR EACH BRANCH CIRCUIT UNLESS HANDLE TIES ARE UTILIZED TO MEET THE REQUIREMENTS OF ARTICLE 210.4(B).
- 21. IN JUNCTION BOXES WHERE CURRENT CARRYING CONDUCTORS ARE SPLICED OR TERMINATED. PROVIDE BOND TO JUNCTION BOX FROM EQUIPMENT GROUNDING CONDUCTOR
- 22. COORDINATE POWER TO BUILDING AUTOMATION SYSTEM CONTROLLERS WITH HVAC/BAS CONTRACTORS. PROVIDE 120V CIRCUIT FROM NEAREST PANELBOARD WITH SPACES TO PROVIDE POWER TO BAS CONTROLLERS. PROVIDE BRANCH CIRCUIT 20A/IP CIRCUIT BREAKER IN PANEL AND 2#12, 1#12G, IN 1/2"C FROM PANEL TO EACH CONTROLLER.
- 23. CONDUCTORS FOR EQUIPMENT RATED 100A AND BELOW ARE SIZED PER ARTICLE 110.14(C)(1)(a)(2) WHICH INDICATES TO UTILIZE THE 60° TEMPERATURE RATING COLUMN OF TABLE 310.15(B)(16) REGARDLESS OF CONDUCTOR INSULATION RATING.

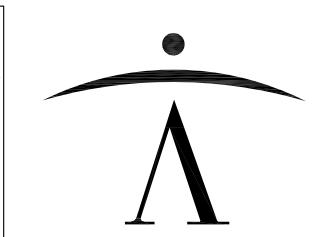

newman architecture 1730 Park Street, Suite 115, Naperville, Illinois 60563-2611 (630) 420-1600 FAX (630) 420-1987 www.newmanarchitecture.com



Project Name:

CONSTRUCTION DOCUMENTS ESWOOD SCHOOL

ROOFING IMPROVEMENTS -**SUMMER 2023**

ESWOOD ELEMENTARY SCHOOL 304 N. MAIN STREET LINDENWOOD, ILLINOIS 61049

BOARD OF EDUCATION ESWOOD CCSD 269

Engineer's Certification:



License: Illinois Professional Design Firm License No. 184-004110 Expires: 2023-04-30

License: Illinois Registration No. 062-040860 Expires: <u>2023-11-30</u>

Drawing Title: **ELECTRICAL SYMBOLS** AND DETAILS

Issue:/ Revision:

No. Date Description 2023-04-18 ISSUED FOR BID

Project Manager: CRN Project No.: 2022052 Date: 2023-04-18